


INFILTRATION TESTING RESULTS						
Test Location	Surface Elevation (Feet, MSL) <sup>1</sup>	Depth to Limiting Zone (Feet)	Limiting Zone Elevation (Feet, MSL)	Infiltration Test Depth (Feet)	Test Elevation (Feet, MSL) (Includes FS=2)	Field Infiltration Rate (inches / hour)
TP-01	337.5	8.5 <sup>2</sup>	329.0	6.0	331.5	0.03
TP-02	336.0	5.0 <sup>2</sup>	331.0	3.0	333.0	4.79
TP-03	343.0	4.5 <sup>2</sup>	338.5	2.5	340.5	0.88
TP-04	338.0	N/E	N/A	4.0	334.0	0.28
TP-05	338.5	N/E	N/A	4.0	332.5	0.28
TP-06	334.0	N/E	N/A	6.0	328.0	0.00
TP-07	333.0	8.5 <sup>2</sup>	324.5	4.0	329.0	1.00
TP-08	334.5	5.5 <sup>2</sup>	329.0	1.5	333.0	2.25
TP-09	335.0	9.0 <sup>2</sup>	326.0	4.0	331.0	0.13
TP-10	332.0	9.0 <sup>2</sup>	323.0	6.0	328.0	0.00
TP-11	332.0	5.5 <sup>2</sup>	326.5	3.5	328.5	0.13
TP-12	332.0	N/E	N/A	4.0	328.0	0.00
TP-13	333.0	7.5 <sup>2</sup>	325.5	3.5	329.5	0.03
TP-14	334.0	5.5 <sup>2</sup>	328.5	5.5	327.5	0.03
TP-15	332.5	N/E	N/A	1.0	333.0	0.00
TP-16	324.0	8.0 <sup>2</sup>	316.0	4.0	320.0	0.06
TP-17	324.0	8.0 <sup>2</sup>	316.0	6.0	320.0	0.00
TP-18	324.0	6.5 <sup>2</sup>	317.5	2.5	321.5	0.50
TP-19	321.0	4.5 <sup>2</sup>	316.5	4.5	319.5	0.00
TP-20	321.0	4.5 <sup>2</sup>	316.5	1.0	320.0	0.03
TP-21	321.0	5.0 <sup>2</sup>	316.0	2.5	318.5	0.38
TP-22	321.0	N/E	N/A	3.0	318.0	0.00
TP-23	336.0	5.0 <sup>2</sup>	331.0	2.5	333.5	0.00
TP-24	349.0	N/E	N/A	4.0	345.0	0.44
TP-25	349.0	N/E	N/A	6.0	343.0	1.00

Note<sup>1</sup>: Please note that the ground surface was not surveyed by a licensed surveyor; these elevations are approximate based on the provided plans; therefore, elevation ranges are approximate +/- half a foot.

Note<sup>2</sup>: Limiting zone is bedrock.

Note<sup>3</sup>: Limiting zone is groundwater.

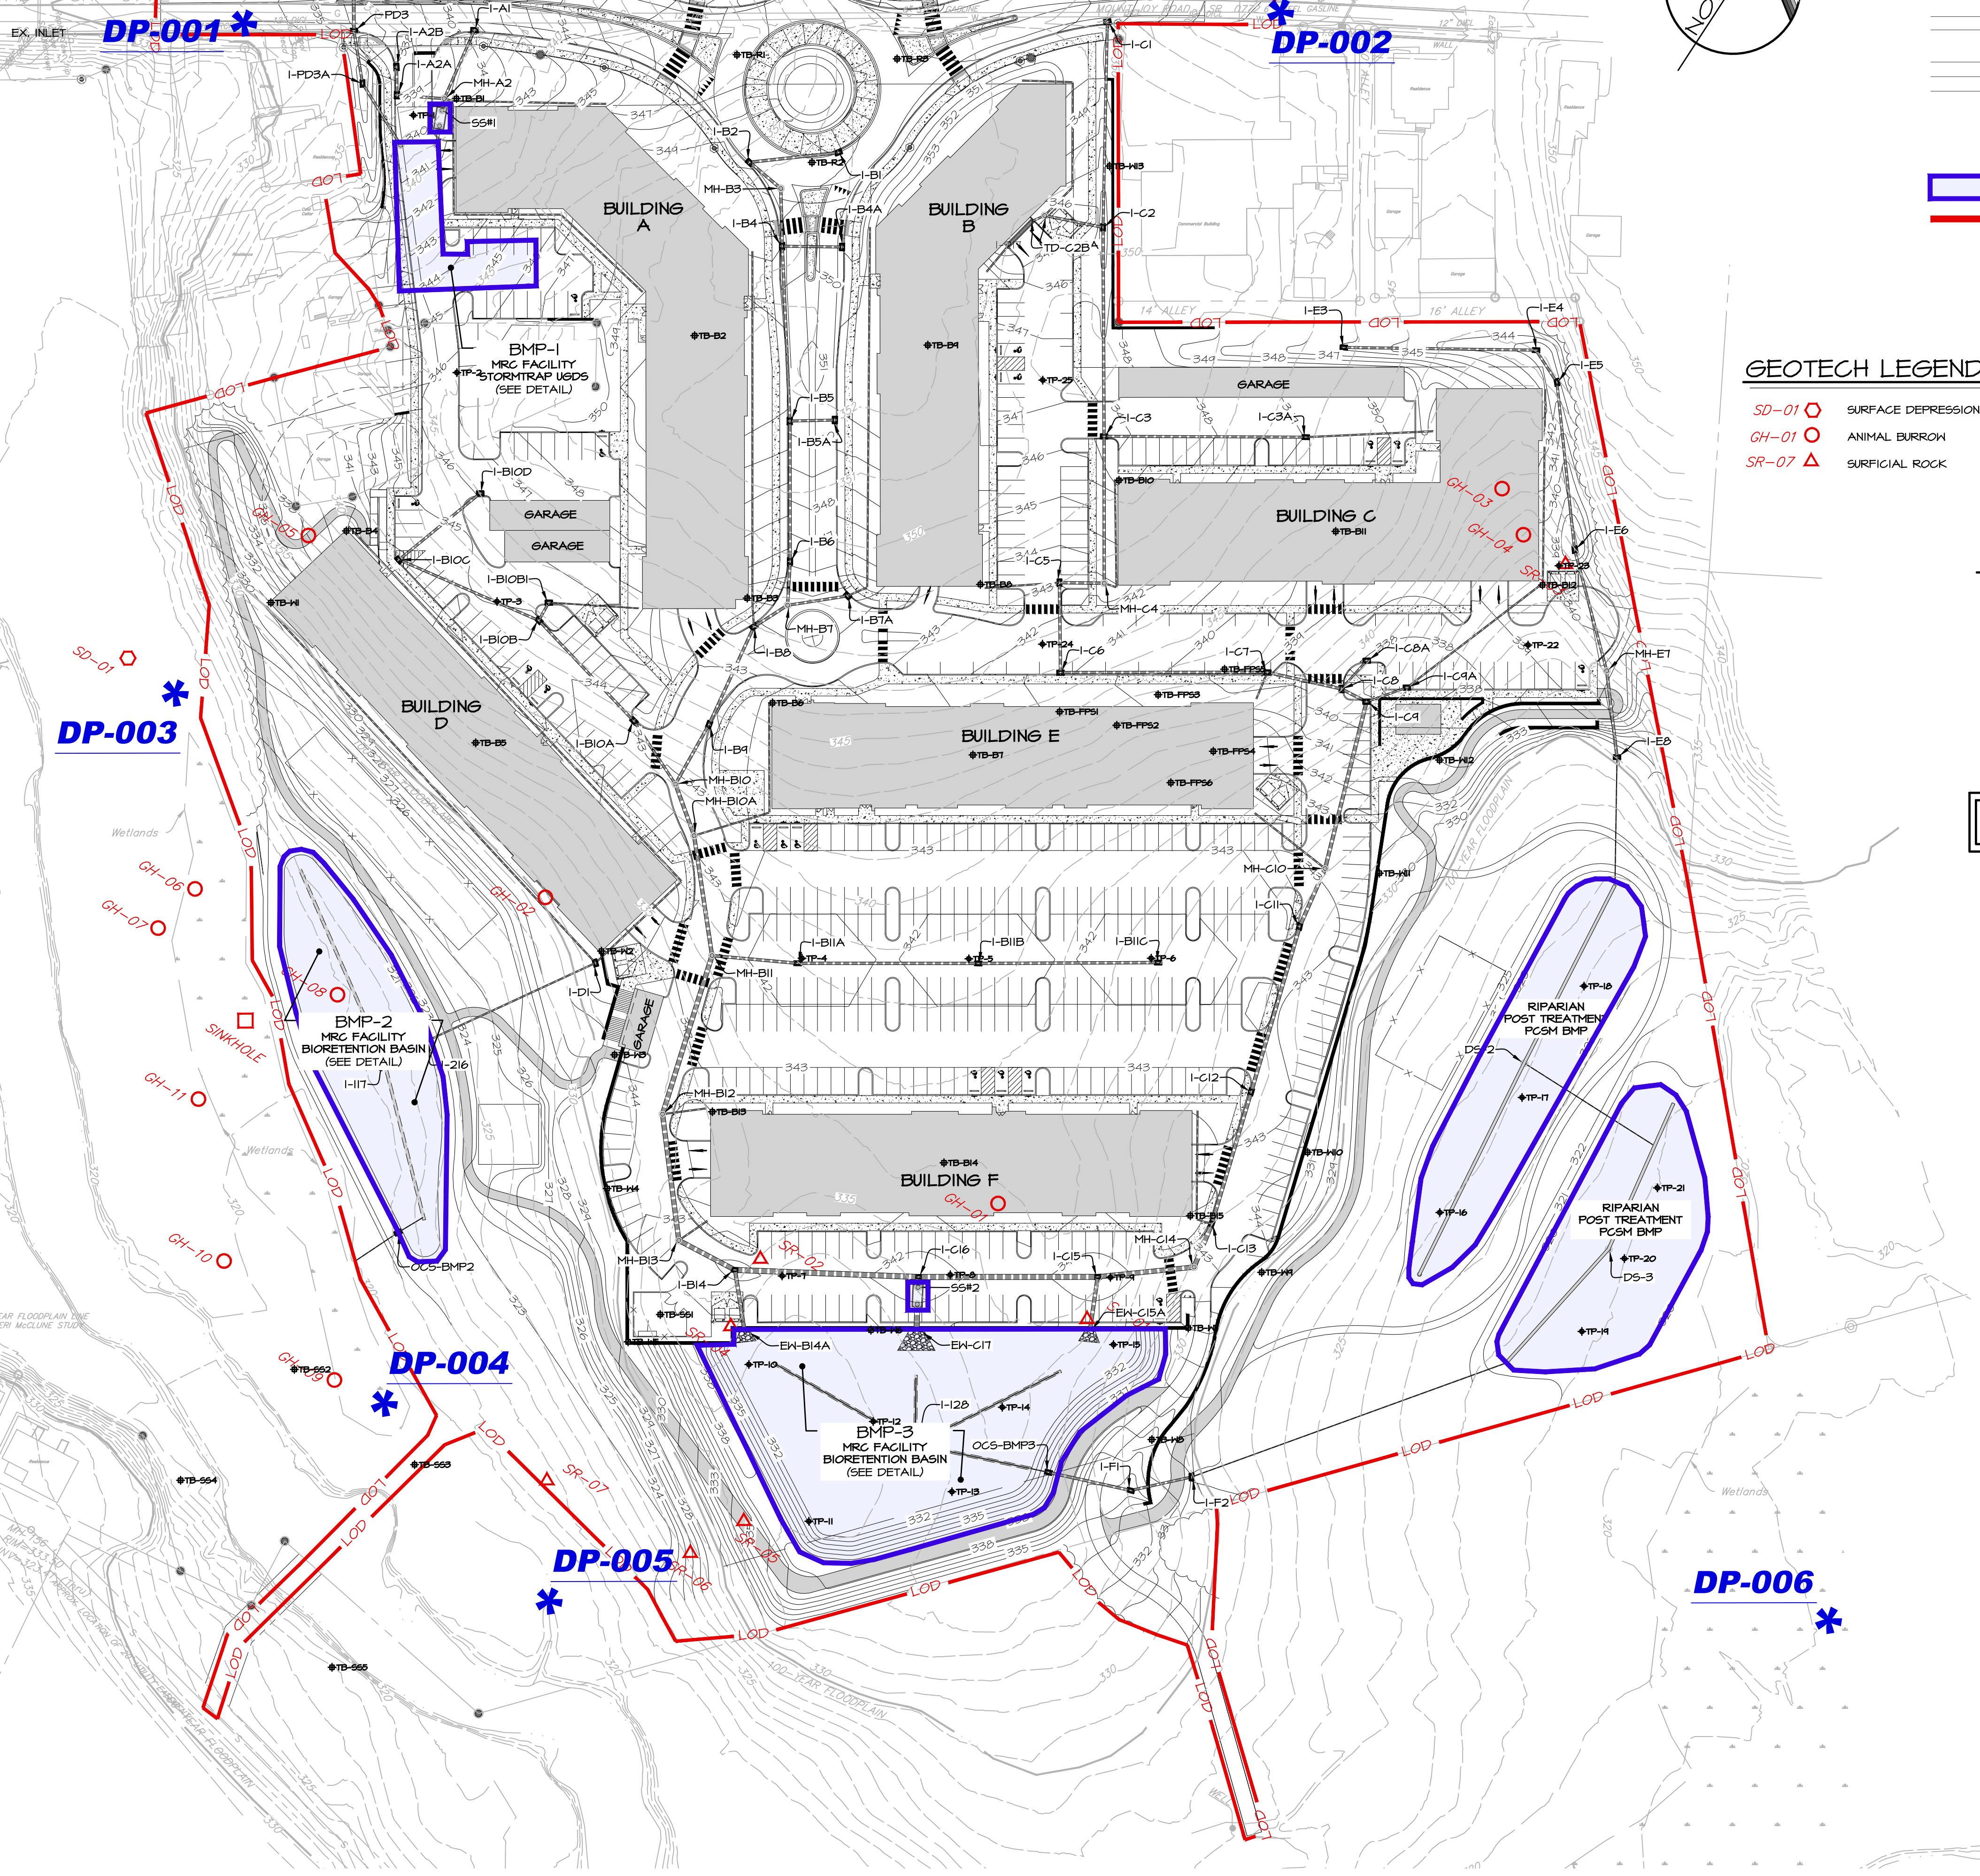

## PCSM LEGEND

- 635 PROPOSED CONTOUR
- 635 EXISTING CONTOUR
- EX. INLET PROPOSED STORM SEWER PIPE/INLET/MANHOLE
- EXISTING ENDWALL/RIP RAP PROPOSED ENDWALL/RIP RAP
- EXISTING SANITARY SEWER AND MANHOLE EXISTING WATER LINE AND VALVE
- EXISTING FIRE HYDRANT EXISTING UNDERGROUND GAS LINE
- EXISTING ABOVE GROUND ELECTRIC LINE EXISTING UNDERGROUND ELECTRIC LINE
- EXISTING SPOT GRADE EXISTING SPOT GRADE
- x 354.05 TEST PIT LOCATION
- T 35250 LOCATION OF PCSM BMP REQUIRING CRITICAL STAGE INSPECTION
- LOD LIMIT OF DISTURBANCE / NPDES PERMIT BOUNDARY

## SOILS LEGEND

- Ha A HAGERSTOWN SILT LOAM, 0-3% SLOPES
- Ha B HAGERSTOWN SILT LOAM, 3-8% SLOPES
- Hb C HAGERSTOWN SILTY CLAY LOAM, 8-15% SLOPES
- Hb D HAGERSTOWN SILTY CLAY LOAM, 15-30% SLOPES
- Hc HAGERSTOWN-URBAN LAND COMPLEX
- Ne NOLIN SILT LOAM
- SD-01 SURFACE DEPRESSION
- GH-01 ANIMAL BURROW
- SR-07 SURFICIAL ROCK

## GEOTECH LEGEND

- SD-01 SURFACE DEPRESSION
  - GH-01 ANIMAL BURROW
  - SR-07 SURFICIAL ROCK
- THE FOLLOWING CRITICAL STAGES OF IMPLEMENTATION OF THE PCSM PLAN REQUIRE A LICENSED PROFESSIONAL OR DESIGNEE BE PRESENT ON-SITE TO OBSERVE CONSTRUCTION
- INITIAL CONSTRUCTION OF SED BASIN "A" AND FINAL CONVERSION TO PCSM BMP-3
  - CONSTRUCTION OF PCSM BMP-2
  - CONSTRUCTION OF BMP-1 USDS
  - INSTALLATION OF SITE SAVER WATER QUALITY UNITS
  - CONSTRUCTION OF RIPARIAN BMPS

## RECEIVING WATERSHED


LITTLE CHIQUES CREEK  
CLASSIFICATION: WNF

LIMIT OF DISTURBANCE = 20 AC

REVISIONS PER:	DATE:	BY:
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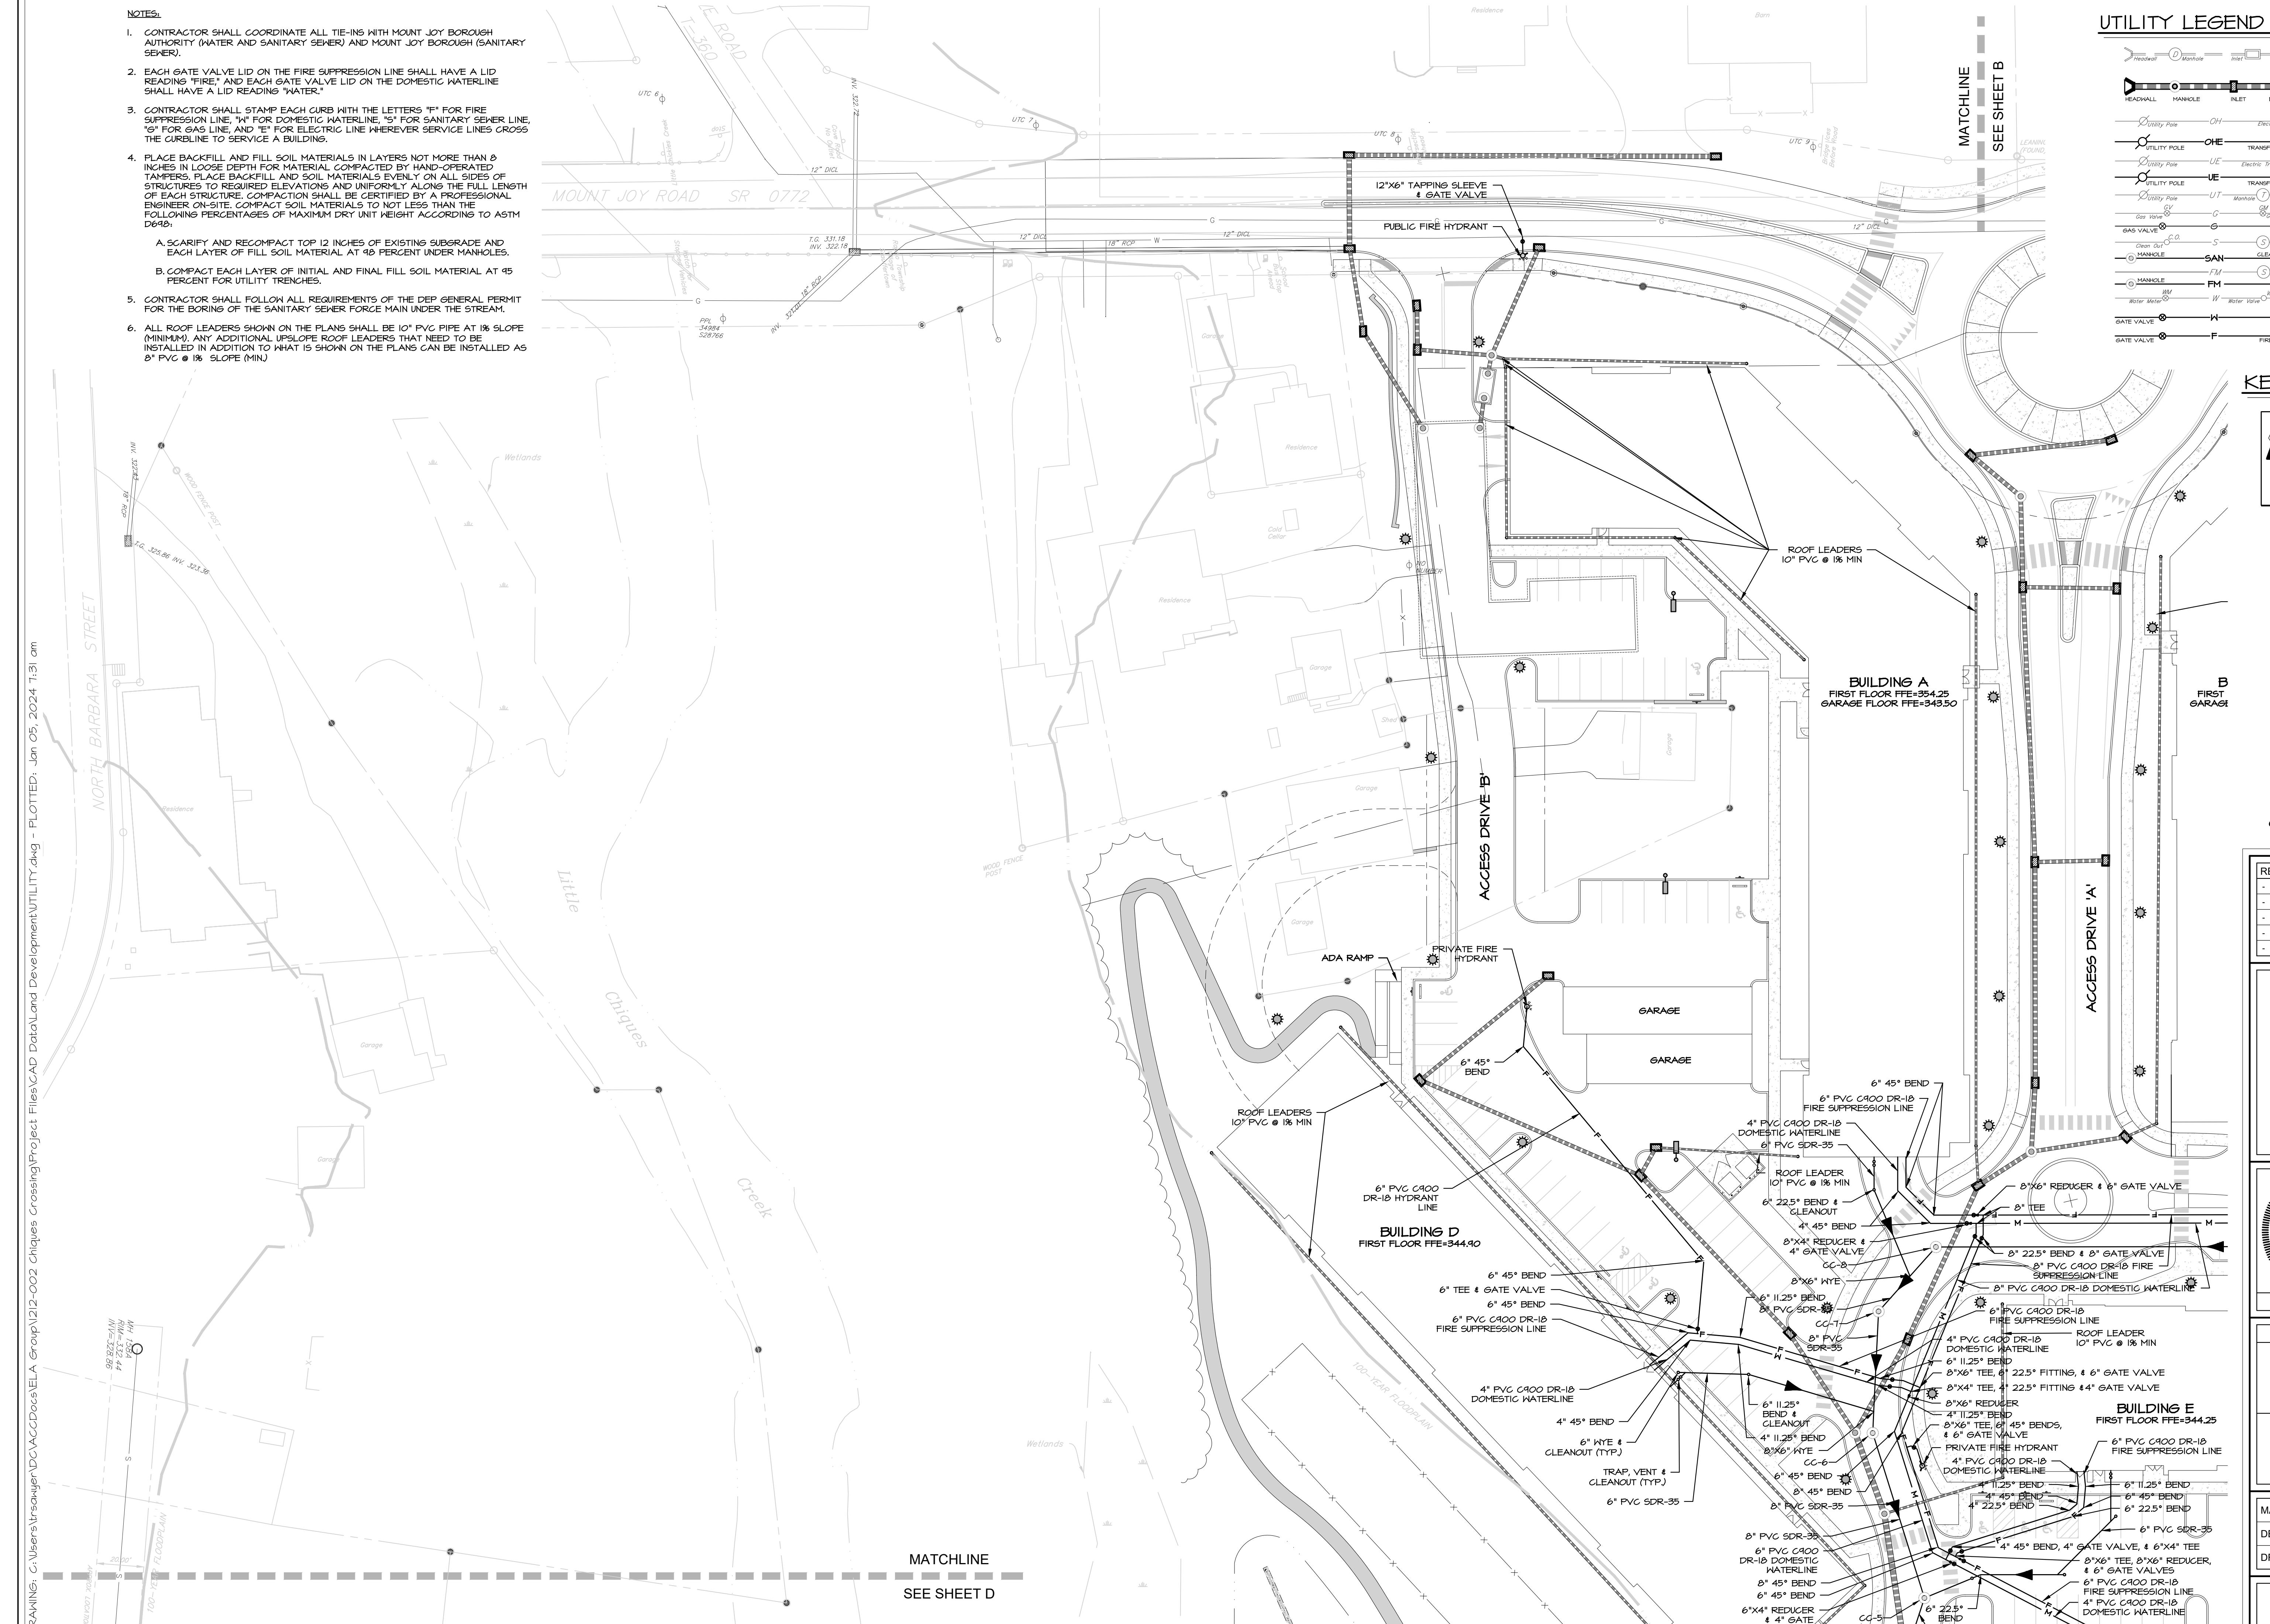
CONDITIONAL USE PLAN		
SUBJECT: PCSM PLAN		
FOR CHIQUES CROSSING RAPHO TOWNSHIP, LANCASTER COUNTY, PENNSYLVANIA		
CLIENT: VISTABLOCK, LLC 150 FARMINGTON LANE LANCASTER, PA 17601 717-682-8775		

MANAGER:	BDG	DATE:	JAN. 5, 2024
DESIGNER:	DJM	PROJECT NO.	1212-002
DRAWN BY:	BLM	SCALE:	1" = 60'


DRAWING NO.  
**27 of 78**

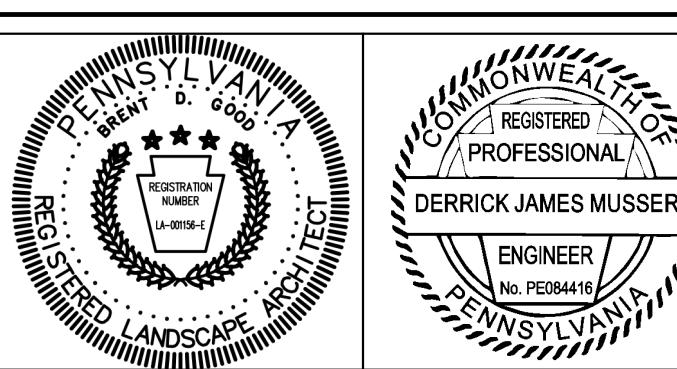NOTES:



- I. CONTRACTOR SHALL COORDINATE ALL TIE-INS WITH MOUNT JOY BOROUGH AUTHORITY (WATER AND SANITARY SEWER) AND MOUNT JOY BOROUGH (SANITARY SEWER).
2. EACH GATE VALVE LID ON THE FIRE SUPPRESSION LINE SHALL HAVE A LID READING "FIRE," AND EACH GATE VALVE LID ON THE DOMESTIC WATERLINE SHALL HAVE A LID READING "WATER."
3. CONTRACTOR SHALL STAMP EACH CURB WITH THE LETTERS "F" FOR FIRE SUPPRESSION LINE, "W" FOR DOMESTIC WATERLINE, "S" FOR SANITARY SEWER LINE, "G" FOR GAS LINE, AND "E" FOR ELECTRIC LINE WHEREVER SERVICE LINES CROSS THE CURBLINE TO SERVICE A BUILDING.
4. PLACE BACKFILL AND FILL SOIL MATERIALS IN LAYERS NOT MORE THAN 8 INCHES IN LOOSE DEPTH FOR MATERIAL COMPAKTED BY HAND-OPERATED TAMPERS. PLACE BACKFILL AND SOIL MATERIALS EVENLY ON ALL SIDES OF STRUCTURES TO REQUIRED ELEVATIONS AND UNIFORMLY ALONG THE FULL LENGTH OF EACH STRUCTURE. COMPAKTION SHALL BE CERTIFIED BY A PROFESSIONAL ENGINEER ON-SITE. COMPACT SOIL MATERIALS TO NOT LESS THAN THE FOLLOWING PERCENTAGES OF MAXIMUM DRY UNIT WEIGHT ACCORDING TO ASTM D698:
  - A. SCARIFY AND RECOMPACT TOP 12 INCHES OF EXISTING SUBGRADE AND EACH LAYER OF FILL SOIL MATERIAL AT 98 PERCENT UNDER MANHOLES.
  - B. COMPACT EACH LAYER OF INITIAL AND FINAL FILL SOIL MATERIAL AT 95 PERCENT FOR UTILITY TRENCHES.
5. CONTRACTOR SHALL FOLLOW ALL REQUIREMENTS OF THE DEP GENERAL PERMIT FOR THE BORING OF THE SANITARY SEWER FORCE MAIN UNDER THE STREAM.
6. ALL ROOF LEADERS SHOWN ON THE PLANS SHALL BE 10" PVC PIPE AT 1% SLOPE (MINIMUM). ANY ADDITIONAL UPSLOPE ROOF LEADERS THAT NEED TO BE INSTALLED IN ADDITION TO WHAT IS SHOWN ON THE PLANS CAN BE INSTALLED AS 8" PVC @ 1% SLOPE (MIN.)



## UTILITY LEGEND

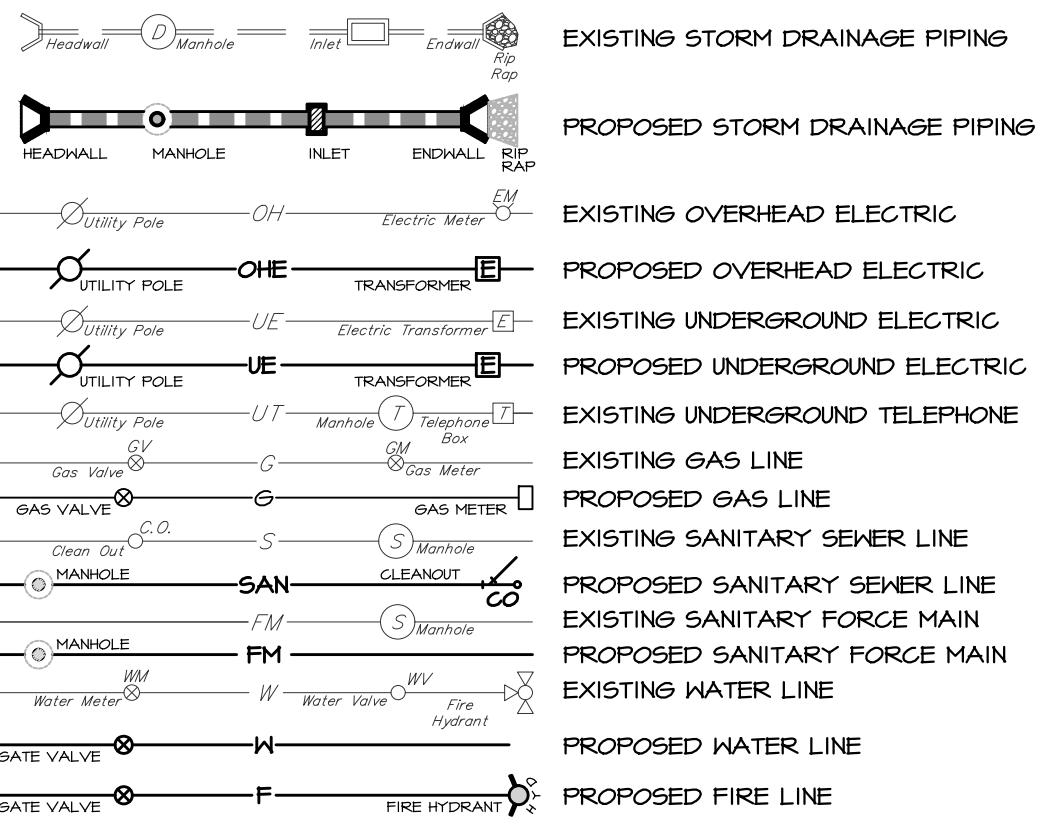


## KEY MAP

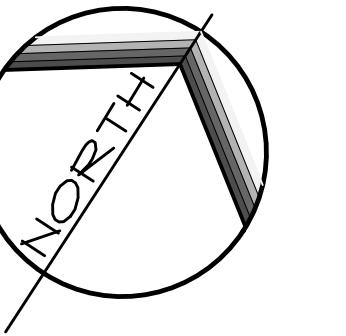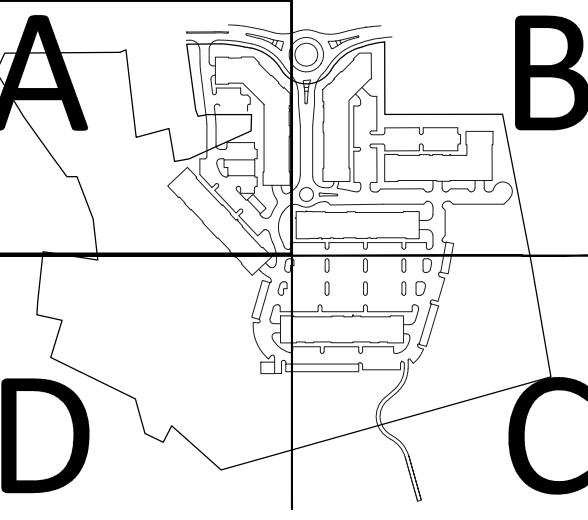

SCALE IN FEET: 1" = 30'

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# CONDITIONAL USE PLAN

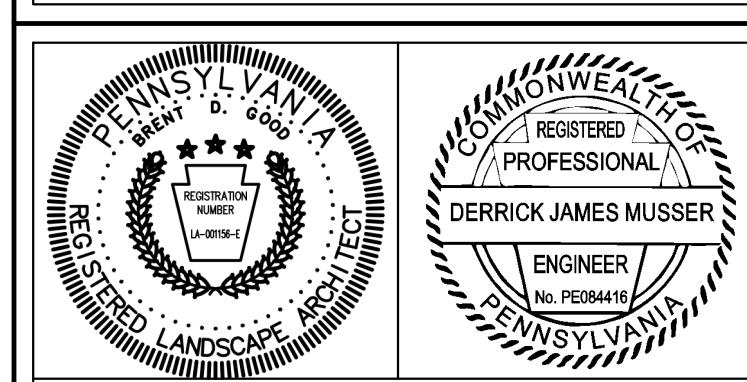SUBJECT:

# **UTILITY PLAN A**

## **FOR**

## **CHIQUES CROSSING**

TOWNSHIP, LANCASTER COUNTY, PENNSYLVANIA  
CLIENT:  
**VISTABLOCK, LLC**  
150 FARMINGTON LANE  
LANCASTER PA 17601


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R:	DJM	PROJECT NO.	1212-002
(1)		SCALING	

Y: BLM | SCALE: 1" = 30'


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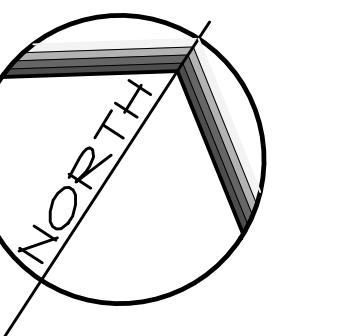
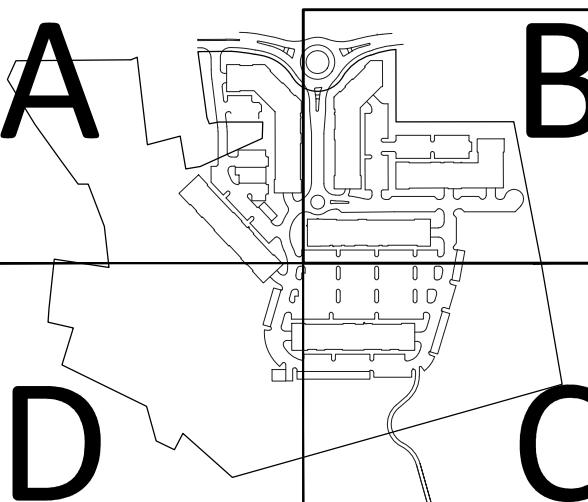
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## UTILITY LEGEND



## KEY MAP

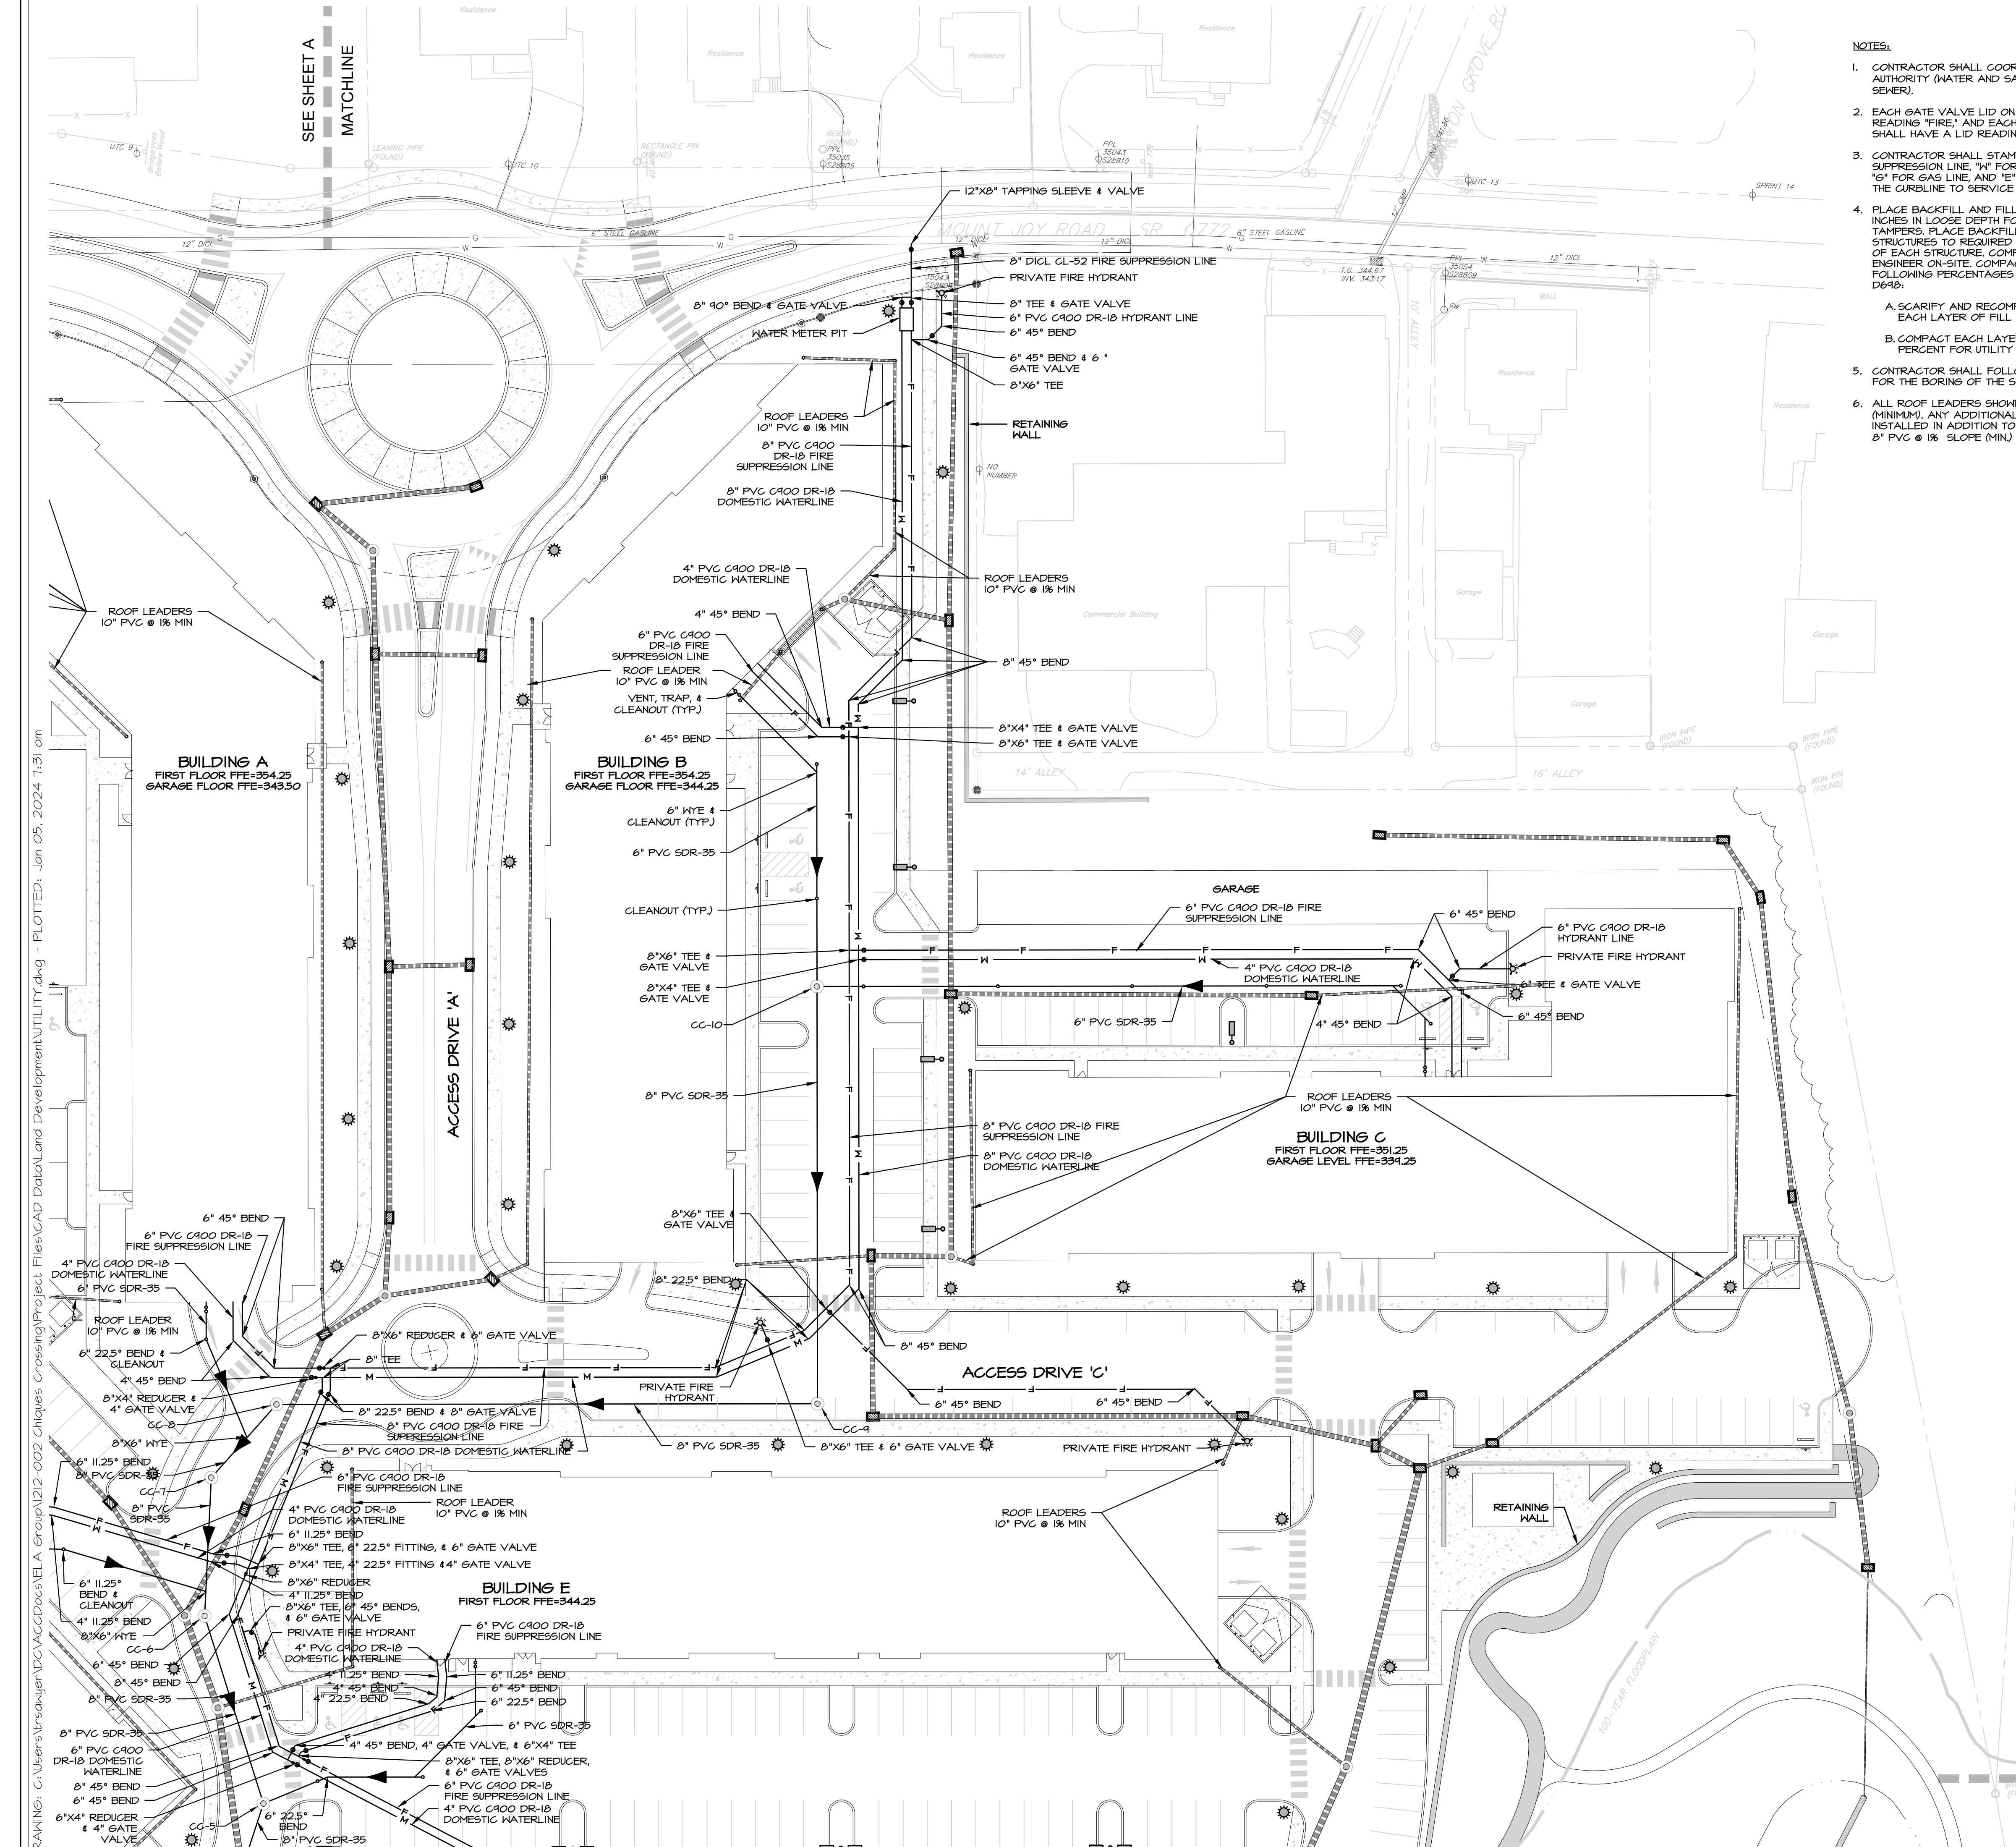

SCALE IN FEET: 1" = 30'

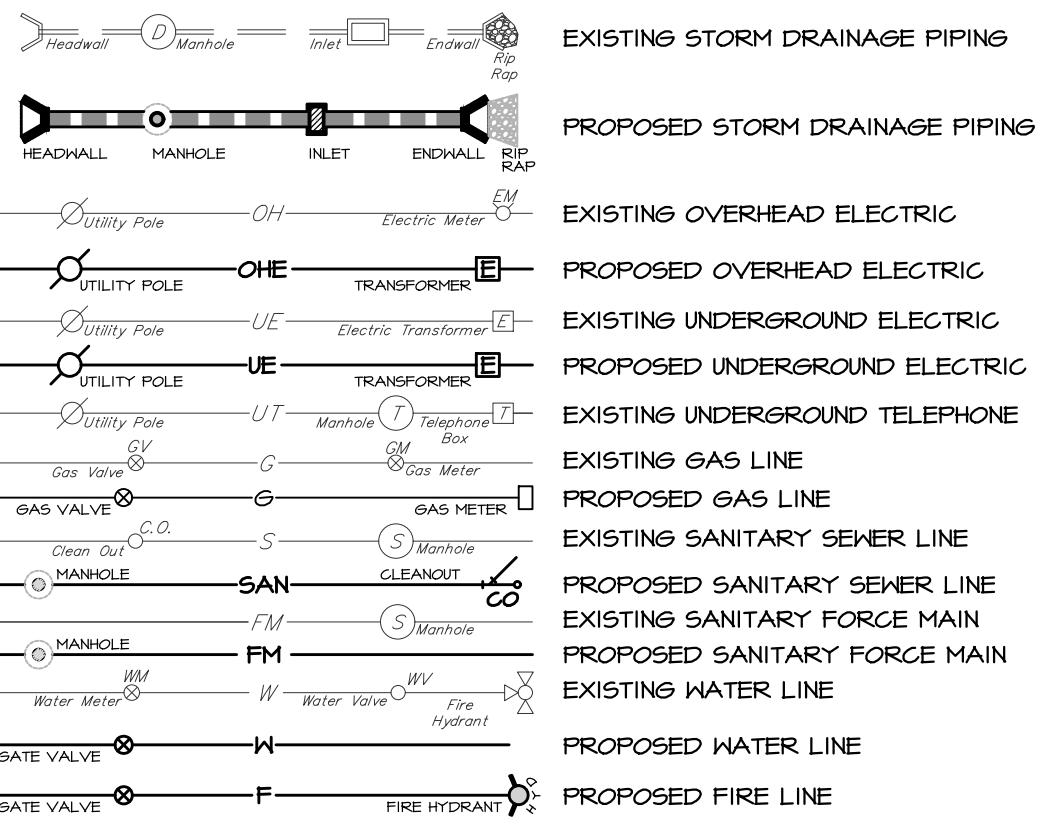

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## CONDITIONAL USE PLAN

SUBJECT:

**UTILITY PLAN B**

FOR  
CHIQUES CROSSING

RAPHO TOWNSHIP, LANCASTER COUNTY, PENNSYLVANIA

**CLIENT:**  
**VISTABLOCK, LLC**  
150 FARMINGTON LANE  
LANCASTER, PA 17601


MANAGER:	BDG	DATE:	JAN. 5, 2024
DESIGNER:	DJM	PROJECT NO.	1212-002

DRAWN BY:	BLM	SCALE:	1" = 30'
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DRAWING NO.
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29 of 78





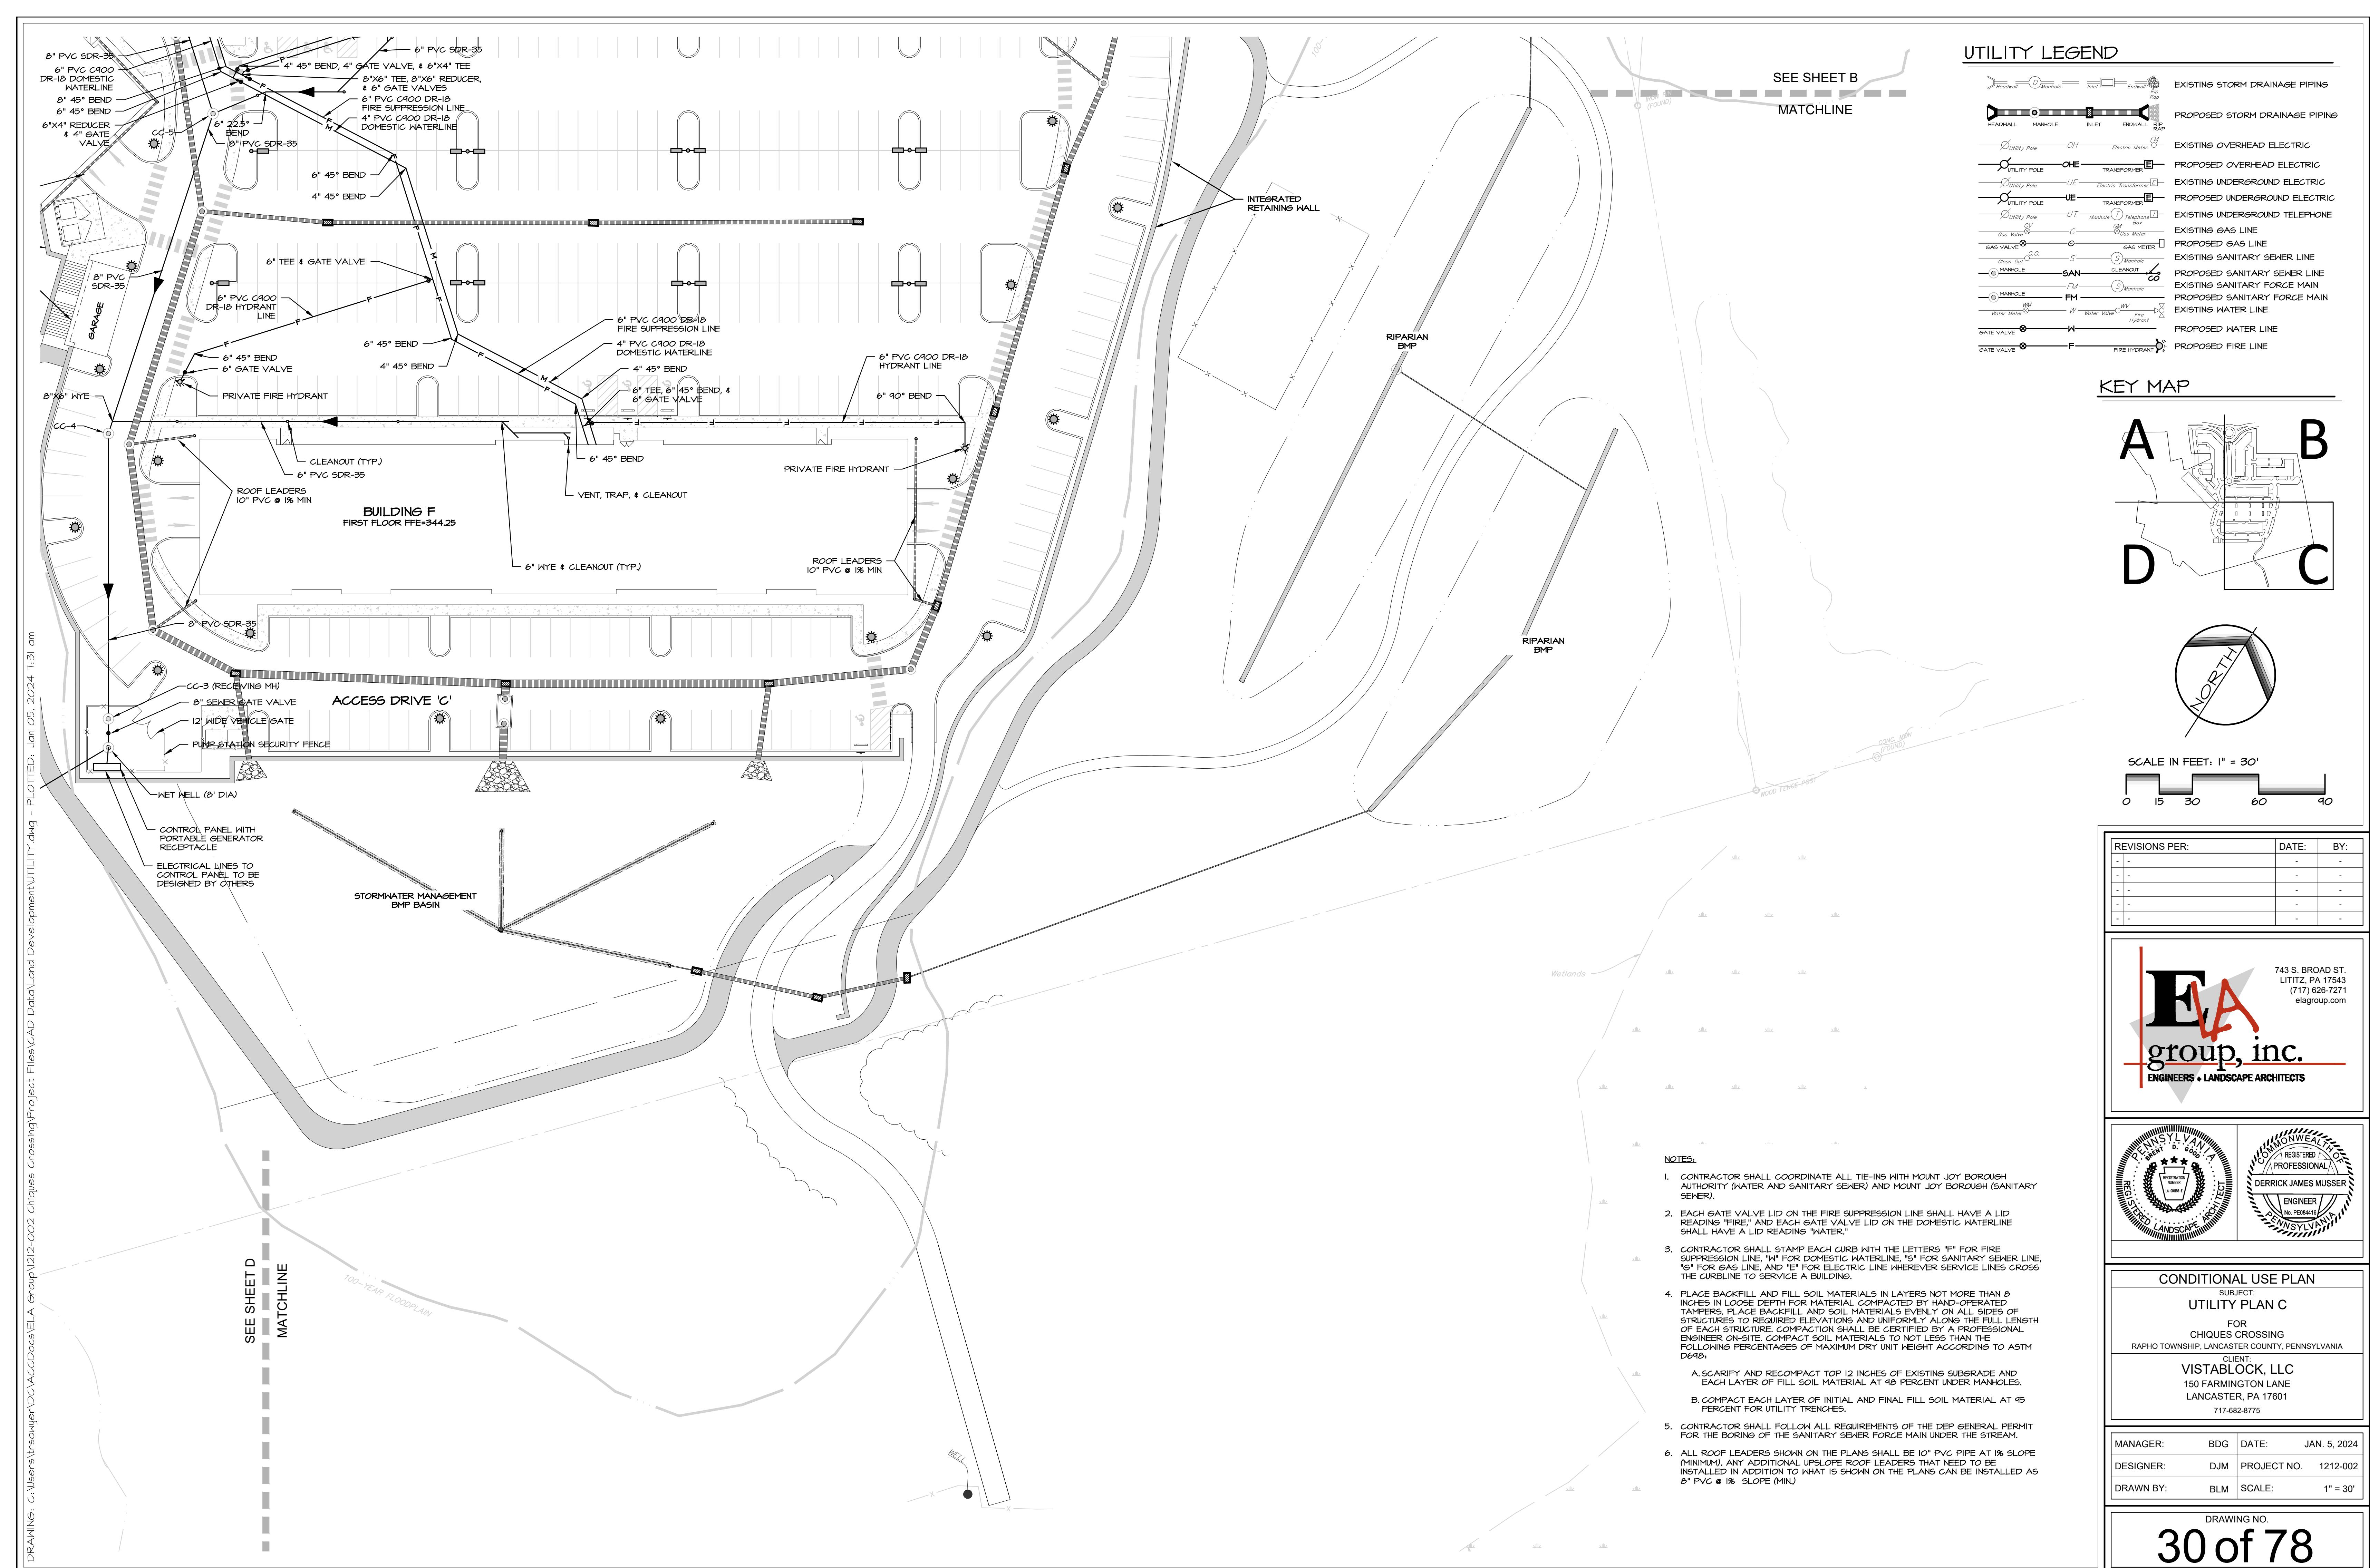

### INTERIOR LANDSCAPE PLANT SCHEDULE

TREES AF	QTY	BOTANICAL NAME	COMMON NAME	SIZE 2" Cal.	REMARKS NATIVE
AR	12	Acer rubrum 'Red Rocket'	Red Rocket Maple	2" Cal.	NATIVE
AG	3	Amelanchier x grandiflora 'Autumn Brilliance'	Autumn Brilliance Apple Serviceberry	5'-6'	NATIVE
BR	5	Betula nigra	River Birch	8'-10'	NATIVE
CC2	1	Cypressus nootkatensis 'Pendula'	Weeping Nootka Cypress	5'-6'	
GA	23	Ginkgo biloba 'Autumn Gold'	Autumn Gold Maidenhair Tree	2" Cal.	
LR	16	Liquidambar styraciflua 'Rotundiloba'	Round-Lobed Sweet Gum	2" Cal.	NATIVE
MR	1	Magnolia stellata 'Royal Star'	Royal Star Magnolia	5'-6'	
PS	17	Pinus strobus	White Pine	6'-8'	NATIVE
PA	3	Prunus x 'Okame'	Okame Flowering Cherry	2" Cal.	
SP	2	Stewartia pseudocamellia	Japanese Stewartia	2" Cal.	
TD	10	Taxodium distichum	Bald Cypress	2" Cal.	NATIVE
TI	7	Thuja x 'Green Giant'	Green Giant Arborvitae	5'-6'	NATIVE
UC	12	Ulmus x 'Frontier'	Frontier Elm	2" Cal.	
ZG	16	Zelkova serrata 'Green Vase'	Green Vase Japanese Zelkova	2" Cal.	

### SHRUBS

CN	2	Chamaecyparis obtusa 'Nana Gracilis'	Graceful Dwarf Hinoki False Cypress	5 Gal.
CV	9	Chionanthus virginicus	White Fringetree	5 Gal.
CF4	18	Cotoneaster franchetti	Orange Cotoneaster	5 Gal.
HO	18	Hydrangea quercifolia 'Snow Queen'	Snow Queen Oakleaf Hydrangea	5 Gal.
IG	16	Ilex glabra	Inkberry Holly	5 Gal.
IC	3	Ilex glabra 'Chamzin'	Nordic Inkberry Holly	5 Gal.
IB	7	Ilex x meserveae 'Blue Princess'	Blue Princess Holly	5 Gal.
IV2	13	Itea virginica 'Henry's Garnet'	Henry's Garnet Sweetspire	5 Gal.
JR	2	Juniperus chinensis 'Robusta Green'	Robust Green Juniper	5 Gal.
JX	14	Juniperus x 'Grey Owl'	Grey Owl Juniper	5 Gal.
PP	1	Photinia pyrifolia	Red Chokeberry	5 Gal.
PJ	13	Physocarpus opulifolius 'Jetam'	First Edition® Amber Jubilee® Ninebark	5 Gal.
RE	13	Rhododendron x 'P.J.M.'	P.J.M. Rhododendron	5 Gal.
RG	3	Rhus aromatica 'Gro-Low'	Gro-Low Fragrant Sumac	5 Gal.
SL	23	Spiraea x bumalda 'Monthub'	Limegrand Spirea	5 Gal.
TS	34	Thuja occidentalis 'Smaragd'	Emerald Green Arborvitae	5 Gal.
VM	11	Viburnum dentatum 'Blue Muffin'	Blue Muffin Arrowwood Viburnum	5 Gal.
VB	12	Viburnum nudum 'Bul'k'	Brandywine Viburnum	5 Gal.

### FLOODPLAIN/RIPARIAN PLANT SCHEDULE

TREES AS	QTY	BOTANICAL NAME	COMMON NAME	SIZE 2" Cal.	REMARKS NATIVE
AA	6	Acer saccharum	Sugar Maple	2" Cal.	
BR	4	Amelanchier arborea	Downy Serviceberry	2" Cal.	NATIVE
CC	10	Betula nigra	River Birch	8'-10'	NATIVE
CF	7	Cercis canadensis	Eastern Redbud	2" Cal.	NATIVE
IA	3	Ilex opaca	Flowering Dogwood	6'-7'	NATIVE
NS	5	Nyssa sylvatica	American Holly	2" Cal.	NATIVE
OV	5	Ostrya virginiana	American Hornbeam	2" Cal.	NATIVE
PO2	31	Picea orientalis	Oriental Spruce	5'-6'	
PS	46	Pinus strobus	White Pine	6'-8'	NATIVE
PO	4	Platanus occidentalis	American Sycamore	2" Cal.	NATIVE
QB	5	Quercus bicolor	Swamp White Oak	2" Cal.	NATIVE
TD	8	Taxodium distichum	Bald Cypress	2" Cal.	NATIVE





### SHRUBS


CO	24	Cephaelanthus occidentalis	Buttonbush	5 Gal.	NATIVE
CA3	15	Clethra alnifolia	Summersweet	5 Gal.	NATIVE
CA4	15	Cornus amomum	Silky Dogwood	5 Gal.	NATIVE
CS	21	Cornus sericea 'Farrow'	Arctic Fire® Red Twig Dogwood	5 Gal.	NATIVE
CF4	12	Cotoneaster franchetti	Orange Cotoneaster	5 Gal.	
HH2	10	Hamamelis virginiana 'Harvest Moon'	Harvest Moon Witch Hazel	5 Gal.	NATIVE
IG	18	Ilex glabra	Inkberry Holly	5 Gal.	NATIVE
IV	8	Ilex verticillata 'Jim Dandy'	Jim Dandy Winterberry	5 Gal.	NATIVE MALE
IR	24	Ilex verticillata 'Red Sprite'	Red Sprite Winterberry	5 Gal.	NATIVE FEMALE
IB	4	Ilex x meserveae 'Blue Princess'	Blue Princess Holly	5 Gal.	
IV2	4	Itea virginica 'Henry's Garnet'	Henry's Garnet Sweetspire	5 Gal.	
LB	5	Lindera benzoin	Spicebush	5 Gal.	NATIVE
PP	31	Photinia pyrifolia	Red Chokeberry	5 Gal.	NATIVE
PJ	10	Physocarpus opulifolius 'Jetam'	First Edition® Amber Jubilee® Ninebark	5 Gal.	NATIVE
RG	15	Rhus aromatica 'Gro-Low'	Gro-Low Fragrant Sumac	5 Gal.	NATIVE
VM	14	Viburnum dentatum 'Blue Muffin'	Blue Muffin Arrowwood Viburnum	5 Gal.	NATIVE
VB	1	Viburnum nudum 'Bul'k'	Brandywine Viburnum	5 Gal.	NATIVE


### GROUND COVERS


AI	361	Acleris incanata	Shrubby Milkweed	1 Gal.	36" o.c.	NATIVE
EP	361	Echinacea purpurea	Coneflower	1 Gal.	36" o.c.	NATIVE
EP3	364	Eupatorium perfoliatum	Common Boneset	1 Gal.	36" o.c.	NATIVE
JE	173	Juncus effusus	Soft Rush	1 Gal.	36" o.c.	NATIVE
LS	156	Liatris spicata	Blazing Star	1 Gal.	36" o.c.	NATIVE
MB	274	Monarda fistulosa	Bergamot	1 Gal.	36" o.c.	NATIVE
PP2	308	Physostegia virginiana 'Pink Marmalade'	Obedient Plant	1 Gal.	36" o.c.	NATIVE
RF	254	Rudbeckia fulgida umbrosa	Orange Coneflower	1 Gal.	36" o.c.	NATIVE

NOTE: FOUNDATION LANDSCAPE DESIGNS FOR ALL BUILDINGS TO BE LIKE BUILDING A FOUNDATION AS SHOWN. DEVELOPER RESERVES THE RIGHT FOR CUSTOMIZATION WITH LANDSCAPE CONTRACTOR.

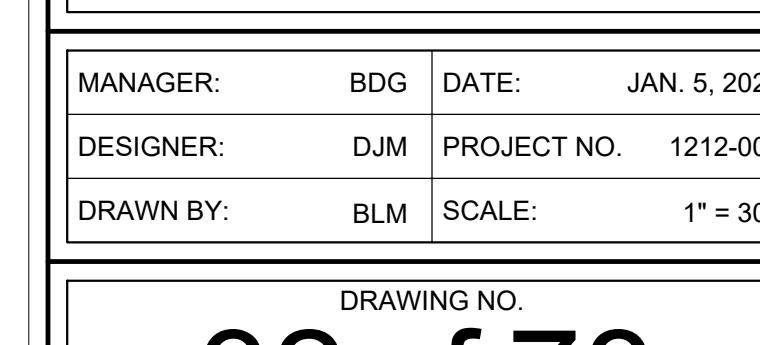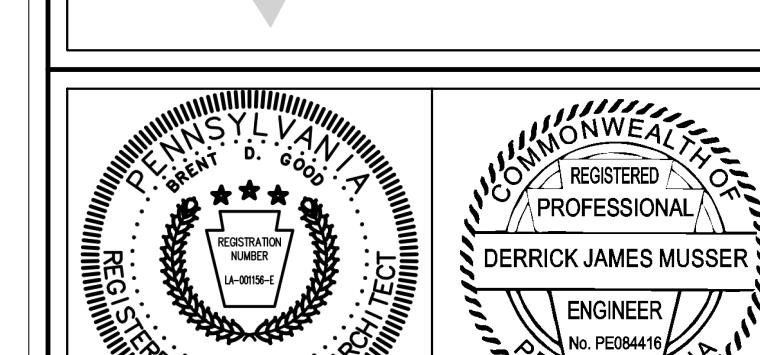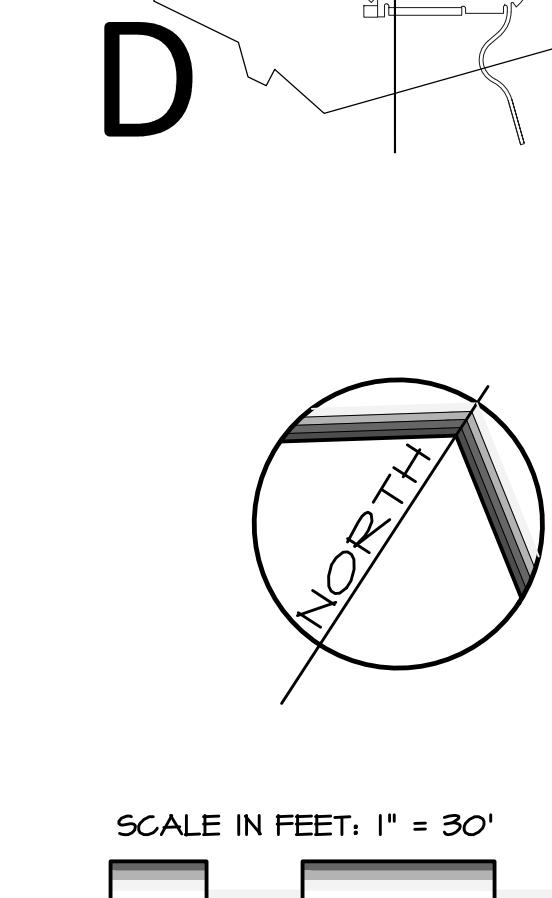
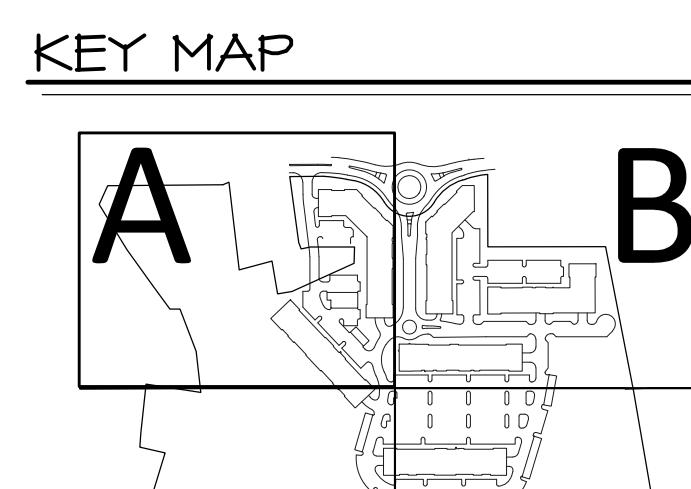


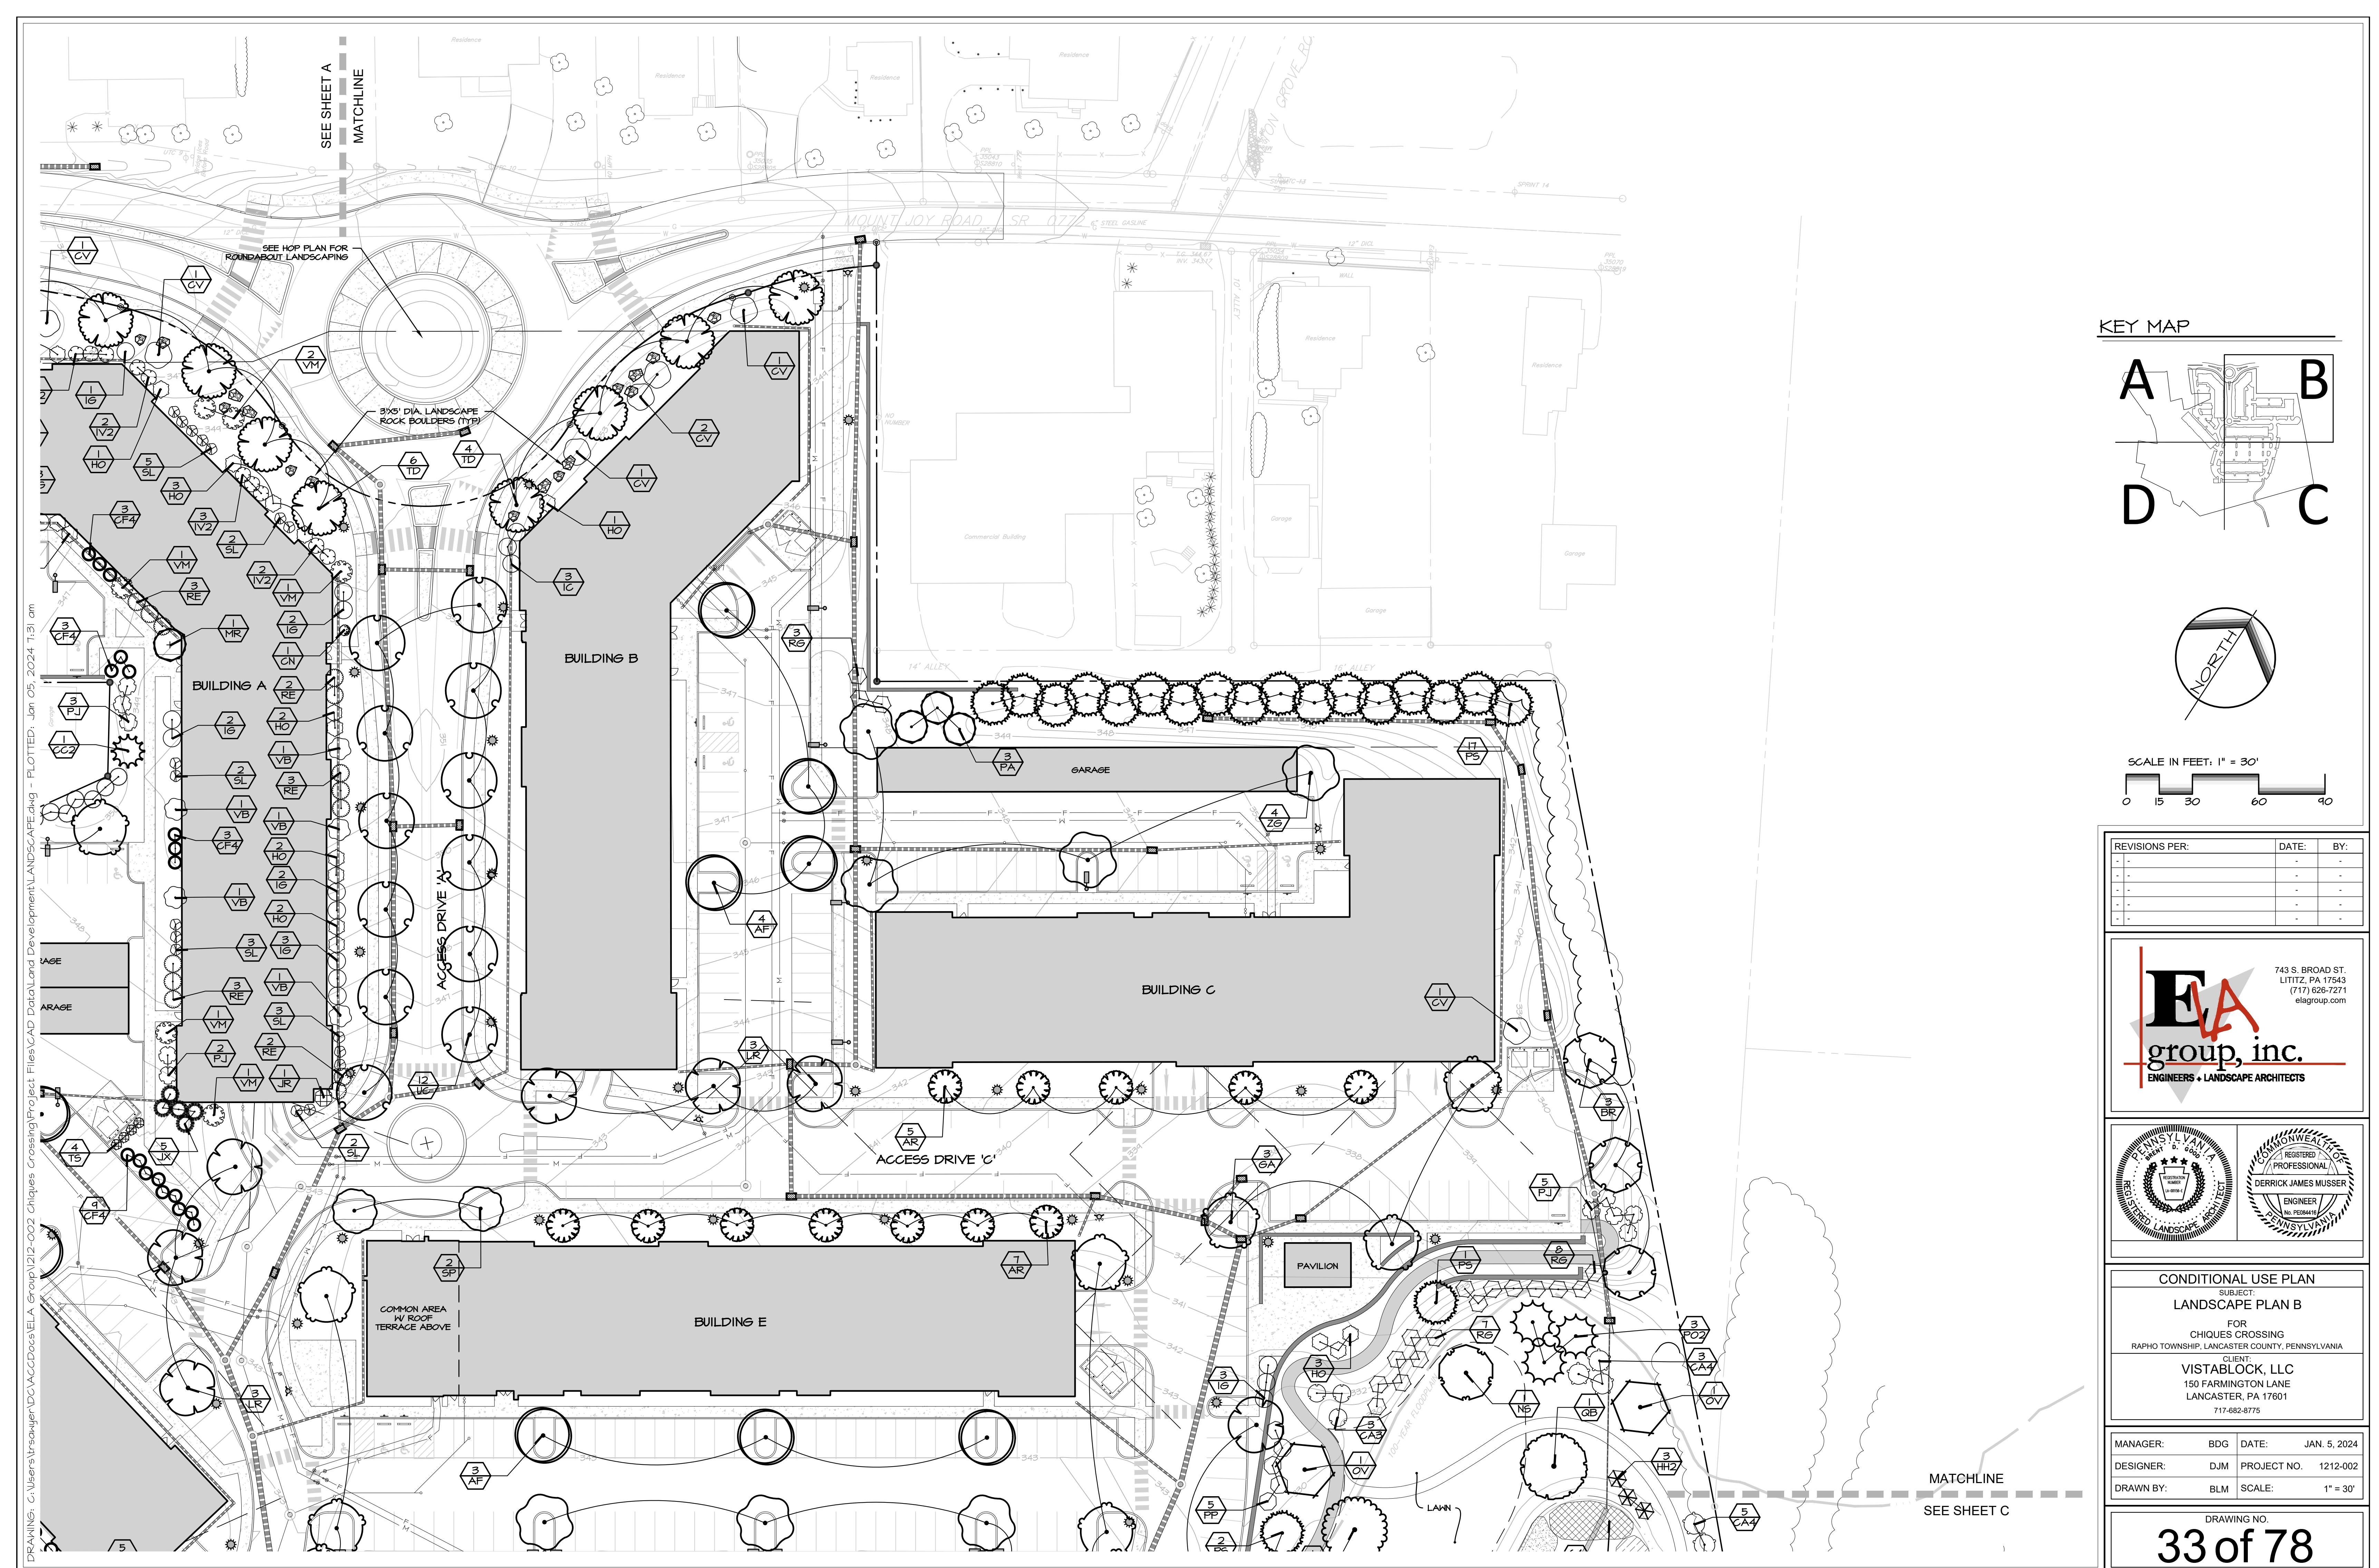

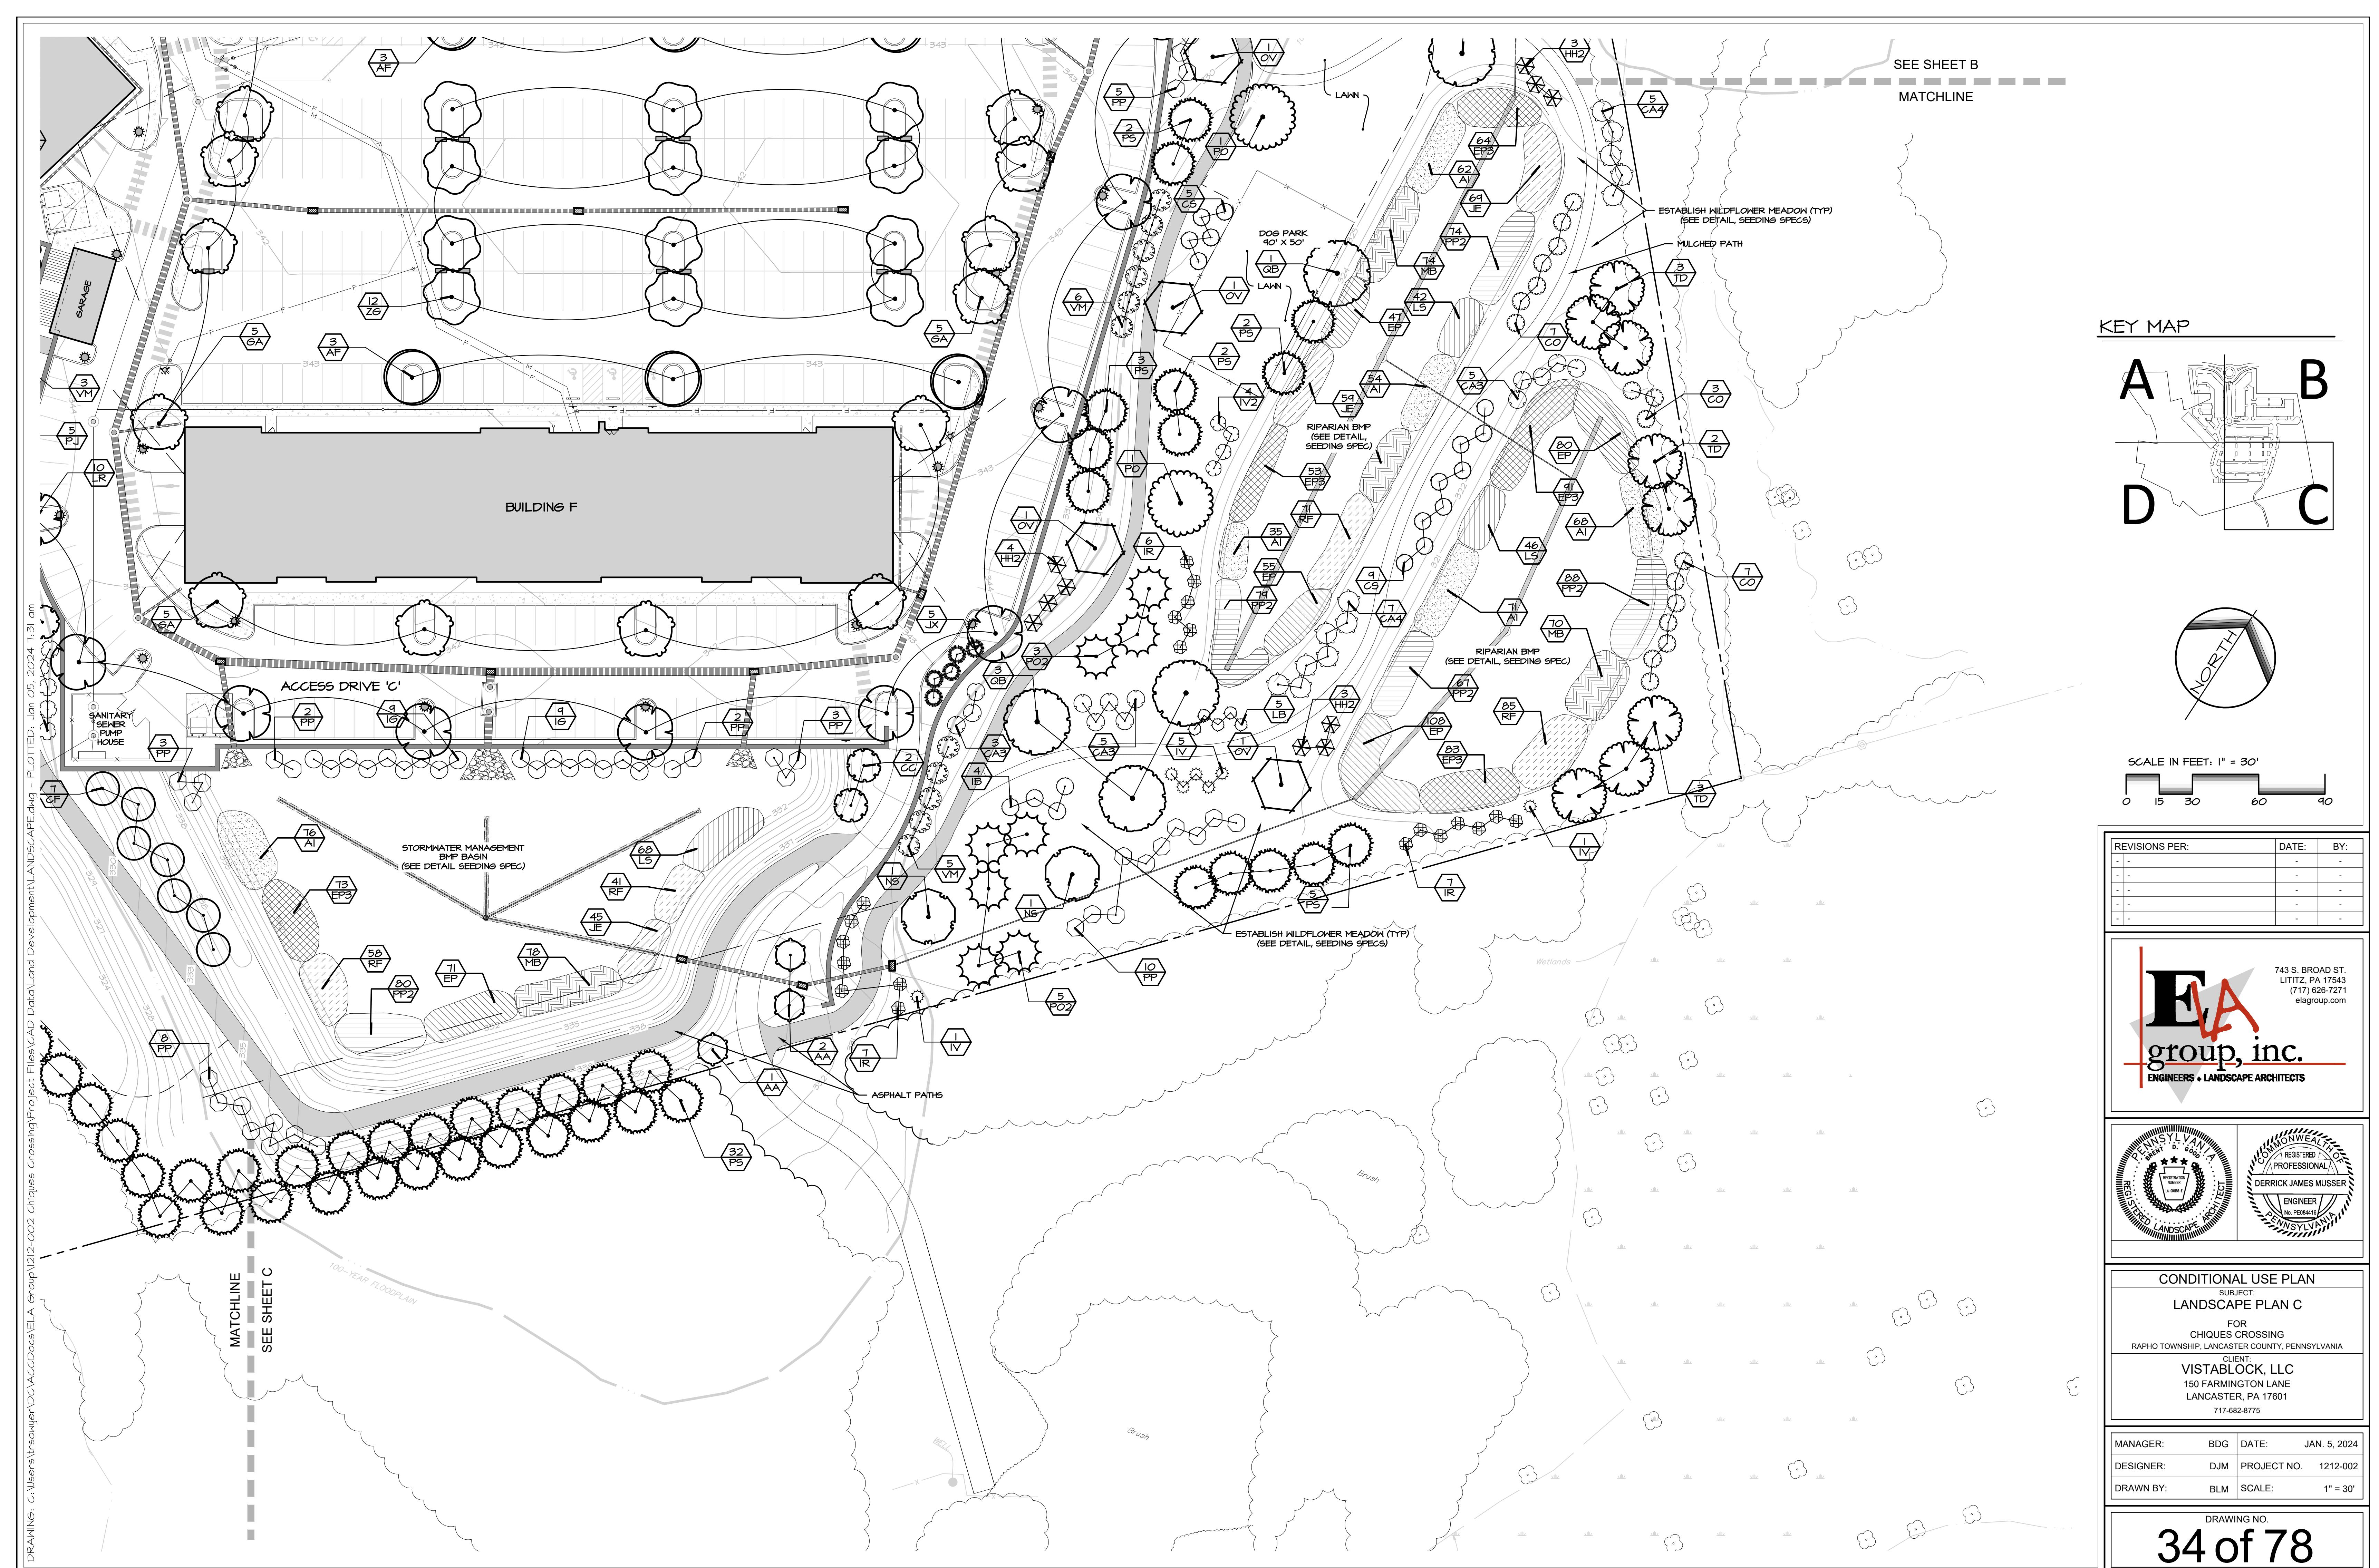

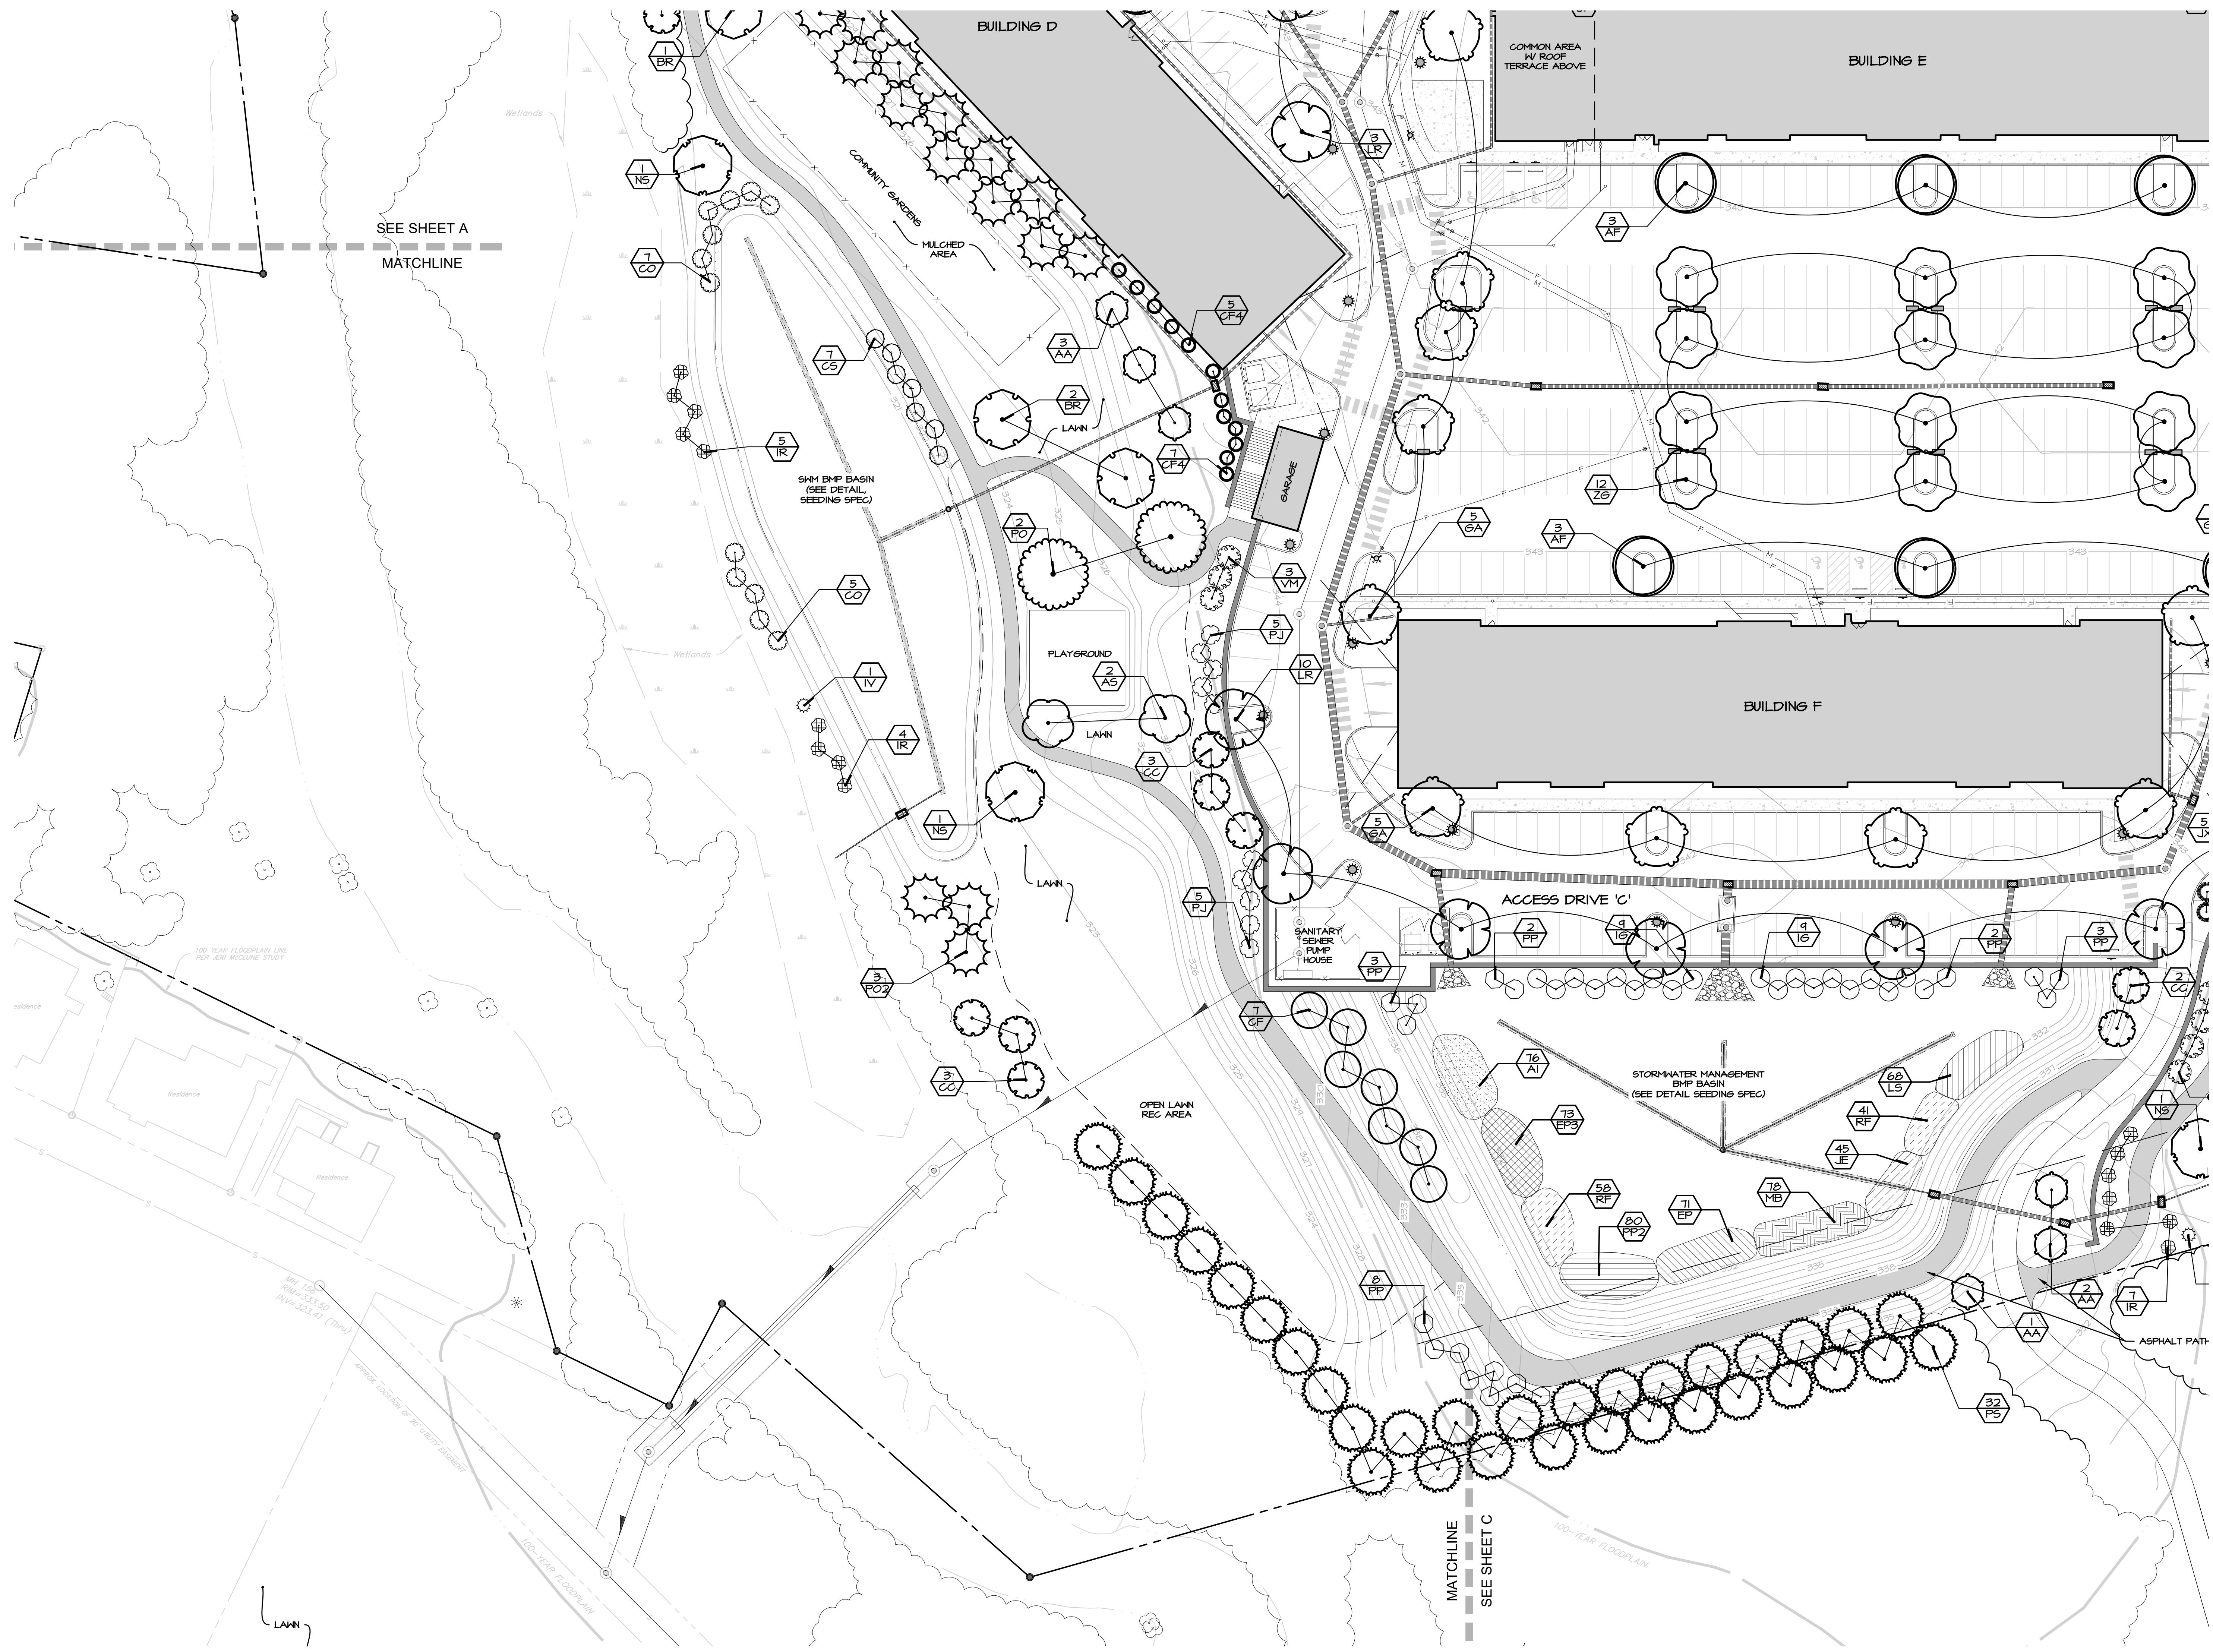

### KEY MAP

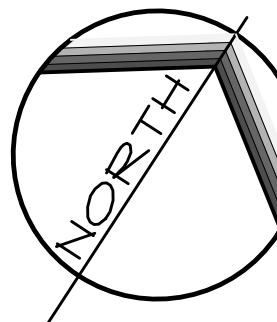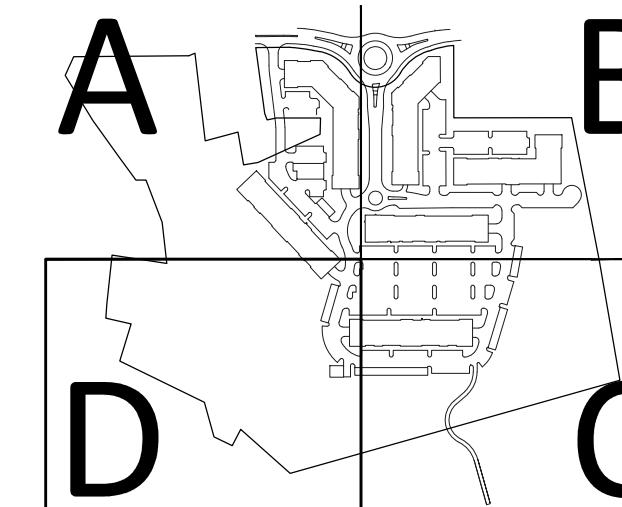


SCALE IN FEET: 1" = 30'  
0 15 30 60 90

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**EA group, inc.**  
ENGINEERS + LANDSCAPE ARCHITECTS

743 S. BROAD ST.  
LITITZ, PA 17543  
(717) 626-7271  
elagroup.com

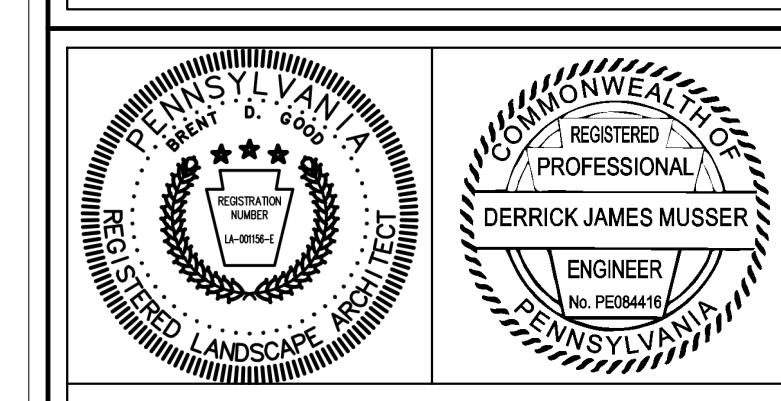

**CONDITIONAL USE PLAN**  
SUBJECT:  
**LANDSCAPE PLAN D**  
FOR  
CHIQUES CROSSING  
RAPHO TOWNSHIP, LANCASTER COUNTY, PENNSYLVANIA  
CLIENT:  
**VISTABLOCK, LLC**  
150 FARMINGTON LANE  
LANCASTER, PA 17601  
717-682-8775

MANAGER:	BDG	DATE:	JAN. 5, 2024
DESIGNER:	DJM	PROJECT NO.	1212-002
DRAWN BY:	BLM	SCALE:	1" = 30'

DRAWING NO.  
**35 of 78**



THE JOURNAL OF CLIMATE



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This architectural site plan details the layout of Mount Joy Road (SR 0772) and surrounding properties. The plan includes:

- Buildings:** BUILDING A, BUILDING B, BUILDING C, BUILDING D, BUILDING E, and a Commercial Building.
- Roads and Alleys:** MOUNT JOY ROAD (SR 0772), 14' ALLEY, and 16' ALLEY.
- Utilities:** MATCHLINE, SPRINKLER SYSTEM, IRON PIPE (FOUND), IRON PIN (FOUND), and REBAR (FOUND).
- Landmarks:** PAVILION, COMMON AREA W/ ROOF TERRACE ABOVE, and a Residential area.
- Annotations:** SEE APPROVED HOP PLANS FOR LIGHTING WITHIN PENNDOT RIGHT-OF-WAY, NO. 17 NUMBER, and various dimensions and notes throughout the plan.


<b>Label</b>	<b>QTY</b>	<b>Manufacturer</b>	<b>Catalog</b>	<b>Description</b>
A	56	Holophane	GPD3 P40 30K XXXX GL3	Granville Premier Gen3, P40 Performance Package, 3000K CCT, Type 3 distribution
B	1	Lithonia Lighting	RSX1 LED P2 30K R4 HS	RSX LED Area Luminaire Size 1 P2 Lumen Package 3000K CCT Type R4 Distribution with HS shield
C	3	Lithonia Lighting	RSX2 LED P2 30K R3 HS	RSX LED Area Luminaire Size 2 P2 Lumen Package 3000K CCT Type R3 Distribution with HS shield
D	6	Lithonia Lighting	RSX1 LED P4 30K R4 HS	RSX LED Area Luminaire Size 1 P4 Lumen Package 3000K CCT Type R4 Distribution with HS shield
E	6	Lithonia Lighting	RSX2 LED P2 30K R3 HS	RSX LED Area Luminaire Size 2 P2 Lumen Package 3000K CCT Type R3 Distribution with HS shield

**MOUNTING HEIGHTS:**  
TYPE A: 12'-0"  
TYPE B: 25'-0"  
TYPE C: AS NOTED ON PLAN  
TYPE D: 25'-0"  
TYPE E: 35'-0"

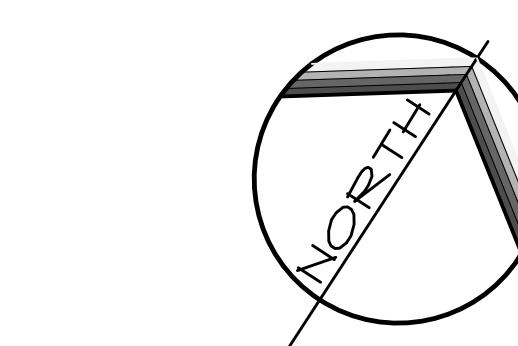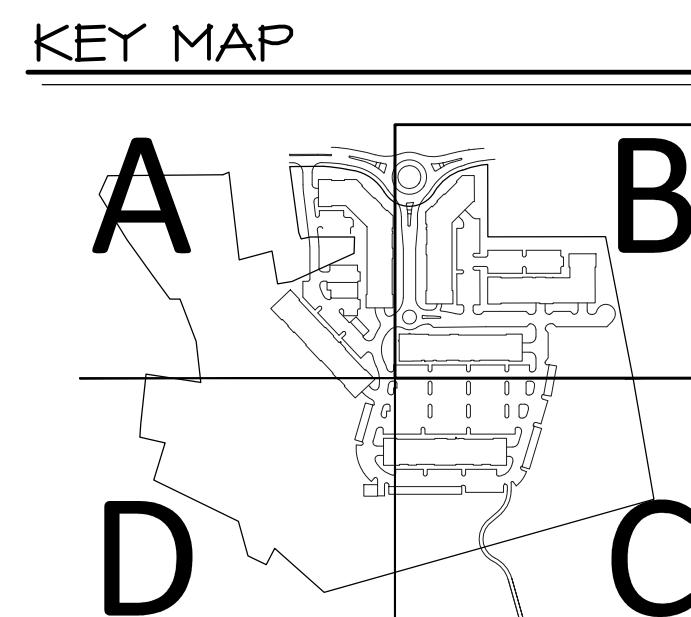

SCALE IN FEET: 1" = 30'

REVISIONS PER:		DATE:
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**CONDITIONAL USE PLAN**  
**SUBJECT:**  
**LIGHTING PLAN B**

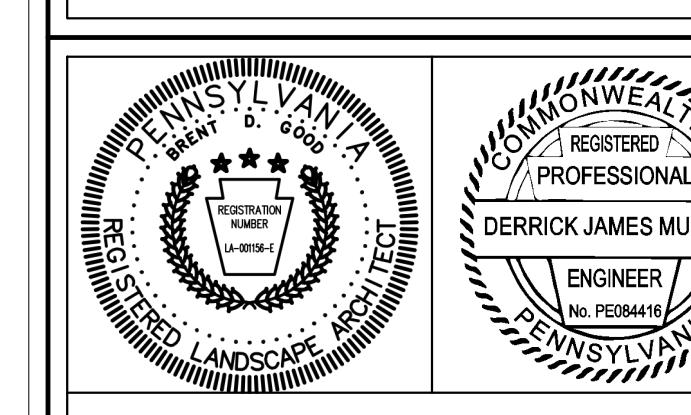**FOR**  
**CHIQUES CROSSING**  
**RAPHO TOWNSHIP, LANCASTER COUNTY, PENNSYLVANIA**

**CLIENT:**  
**VISTABLOCK, LLC**  
**150 FARMINGTON LANE**  
**LANCASTER, PA 17601**

**717-682-8775**

MANAGER:	BDG	DATE:	JAN.
DESIGNER:	DJM	PROJECT NO.	12
DRAWN BY:	BLM	SCALE:	1

DRAWING NO.  
**37 of 78**







Label	QTY	Manufacturer	Catalog	Description
A	56	Holophane	GPD3 P40 30K XXXX GL3	Granville Premier Gen3, P40 Performance Package, 3000K CCT, Type 3 distribution
B	1	Lithonia Lighting	RSX1 LED P2 30K R4 HS	RSX LED Area Luminaire Size 1 P2 Lumen Package 3000K CCT Type R4 Distribution with HS shield
C	3	Lithonia Lighting	RSX2 LED P2 30K R3 HS	RSX LED Area Luminaire Size 2 P2 Lumen Package 3000K CCT Type R3 Distribution with HS shield
D	6	Lithonia Lighting	RSX1 LED P4 30K R4 HS	RSX LED Area Luminaire Size 1 P4 Lumen Package 3000K CCT Type R4 Distribution with HS shield
E	6	Lithonia Lighting	RSX2 LED P2 30K R3 HS	RSX LED Area Luminaire Size 2 P2 Lumen Package 3000K CCT Type R3 Distribution with HS shield


MOUNTING HEIGHTS:  
TYPE A: 12'-0"  
TYPE B: 8'-0"  
TYPE C: AS NOTED ON PLAN  
TYPE D: 25'-0"  
TYPE E: 35'-0"

### KEY MAP

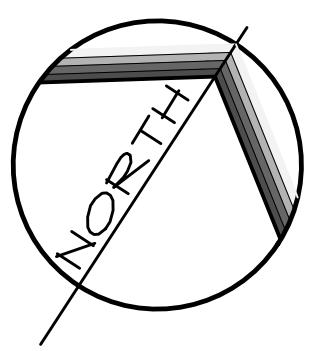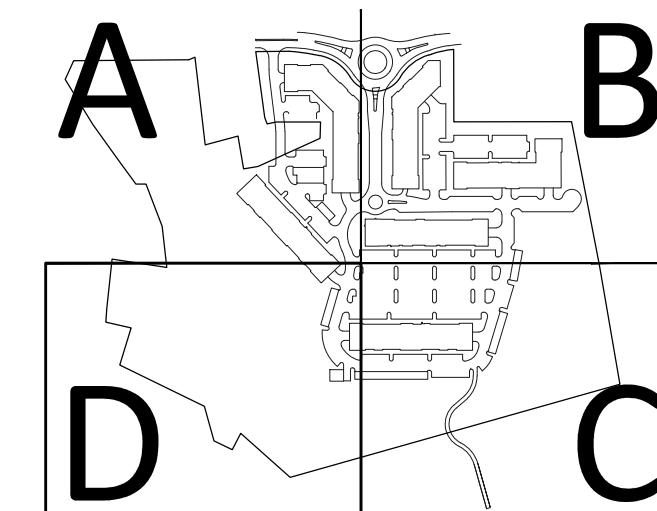

SCALE IN FEET: 1" = 30'  
0 15 30 60 90





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743 S. BROAD ST.  
LITITZ, PA 17543  
(717) 626-7271  
elagroup.com

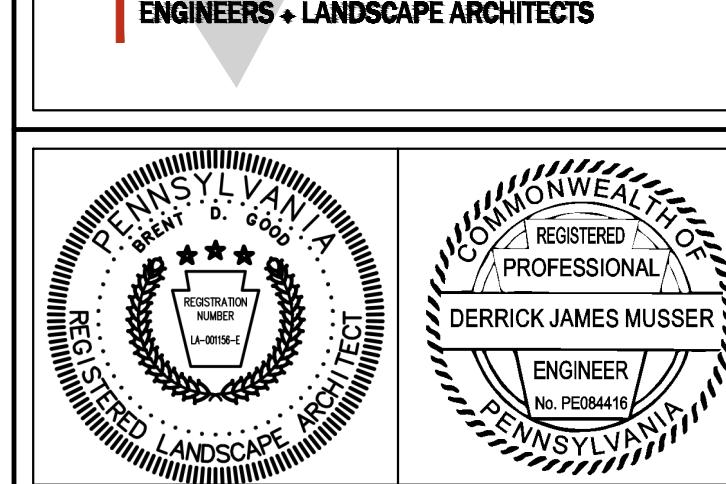

CONDITIONAL USE PLAN  
SUBJECT: LIGHTING PLAN D  
FOR CHIQUES CROSSING  
RAPHO TOWNSHIP, LANCASTER COUNTY, PENNSYLVANIA  
CLIENT: VISTABLOCK, LLC  
150 FARMINGTON LANE  
LANCASTER, PA 17601  
717-682-8775

MANAGER: BDG DATE: JAN 5, 2024  
DESIGNER: DJM PROJECT NO. 1212-002  
DRAWN BY: BLM SCALE: 1" = 30'

DRAWING NO.  
**39 of 78**

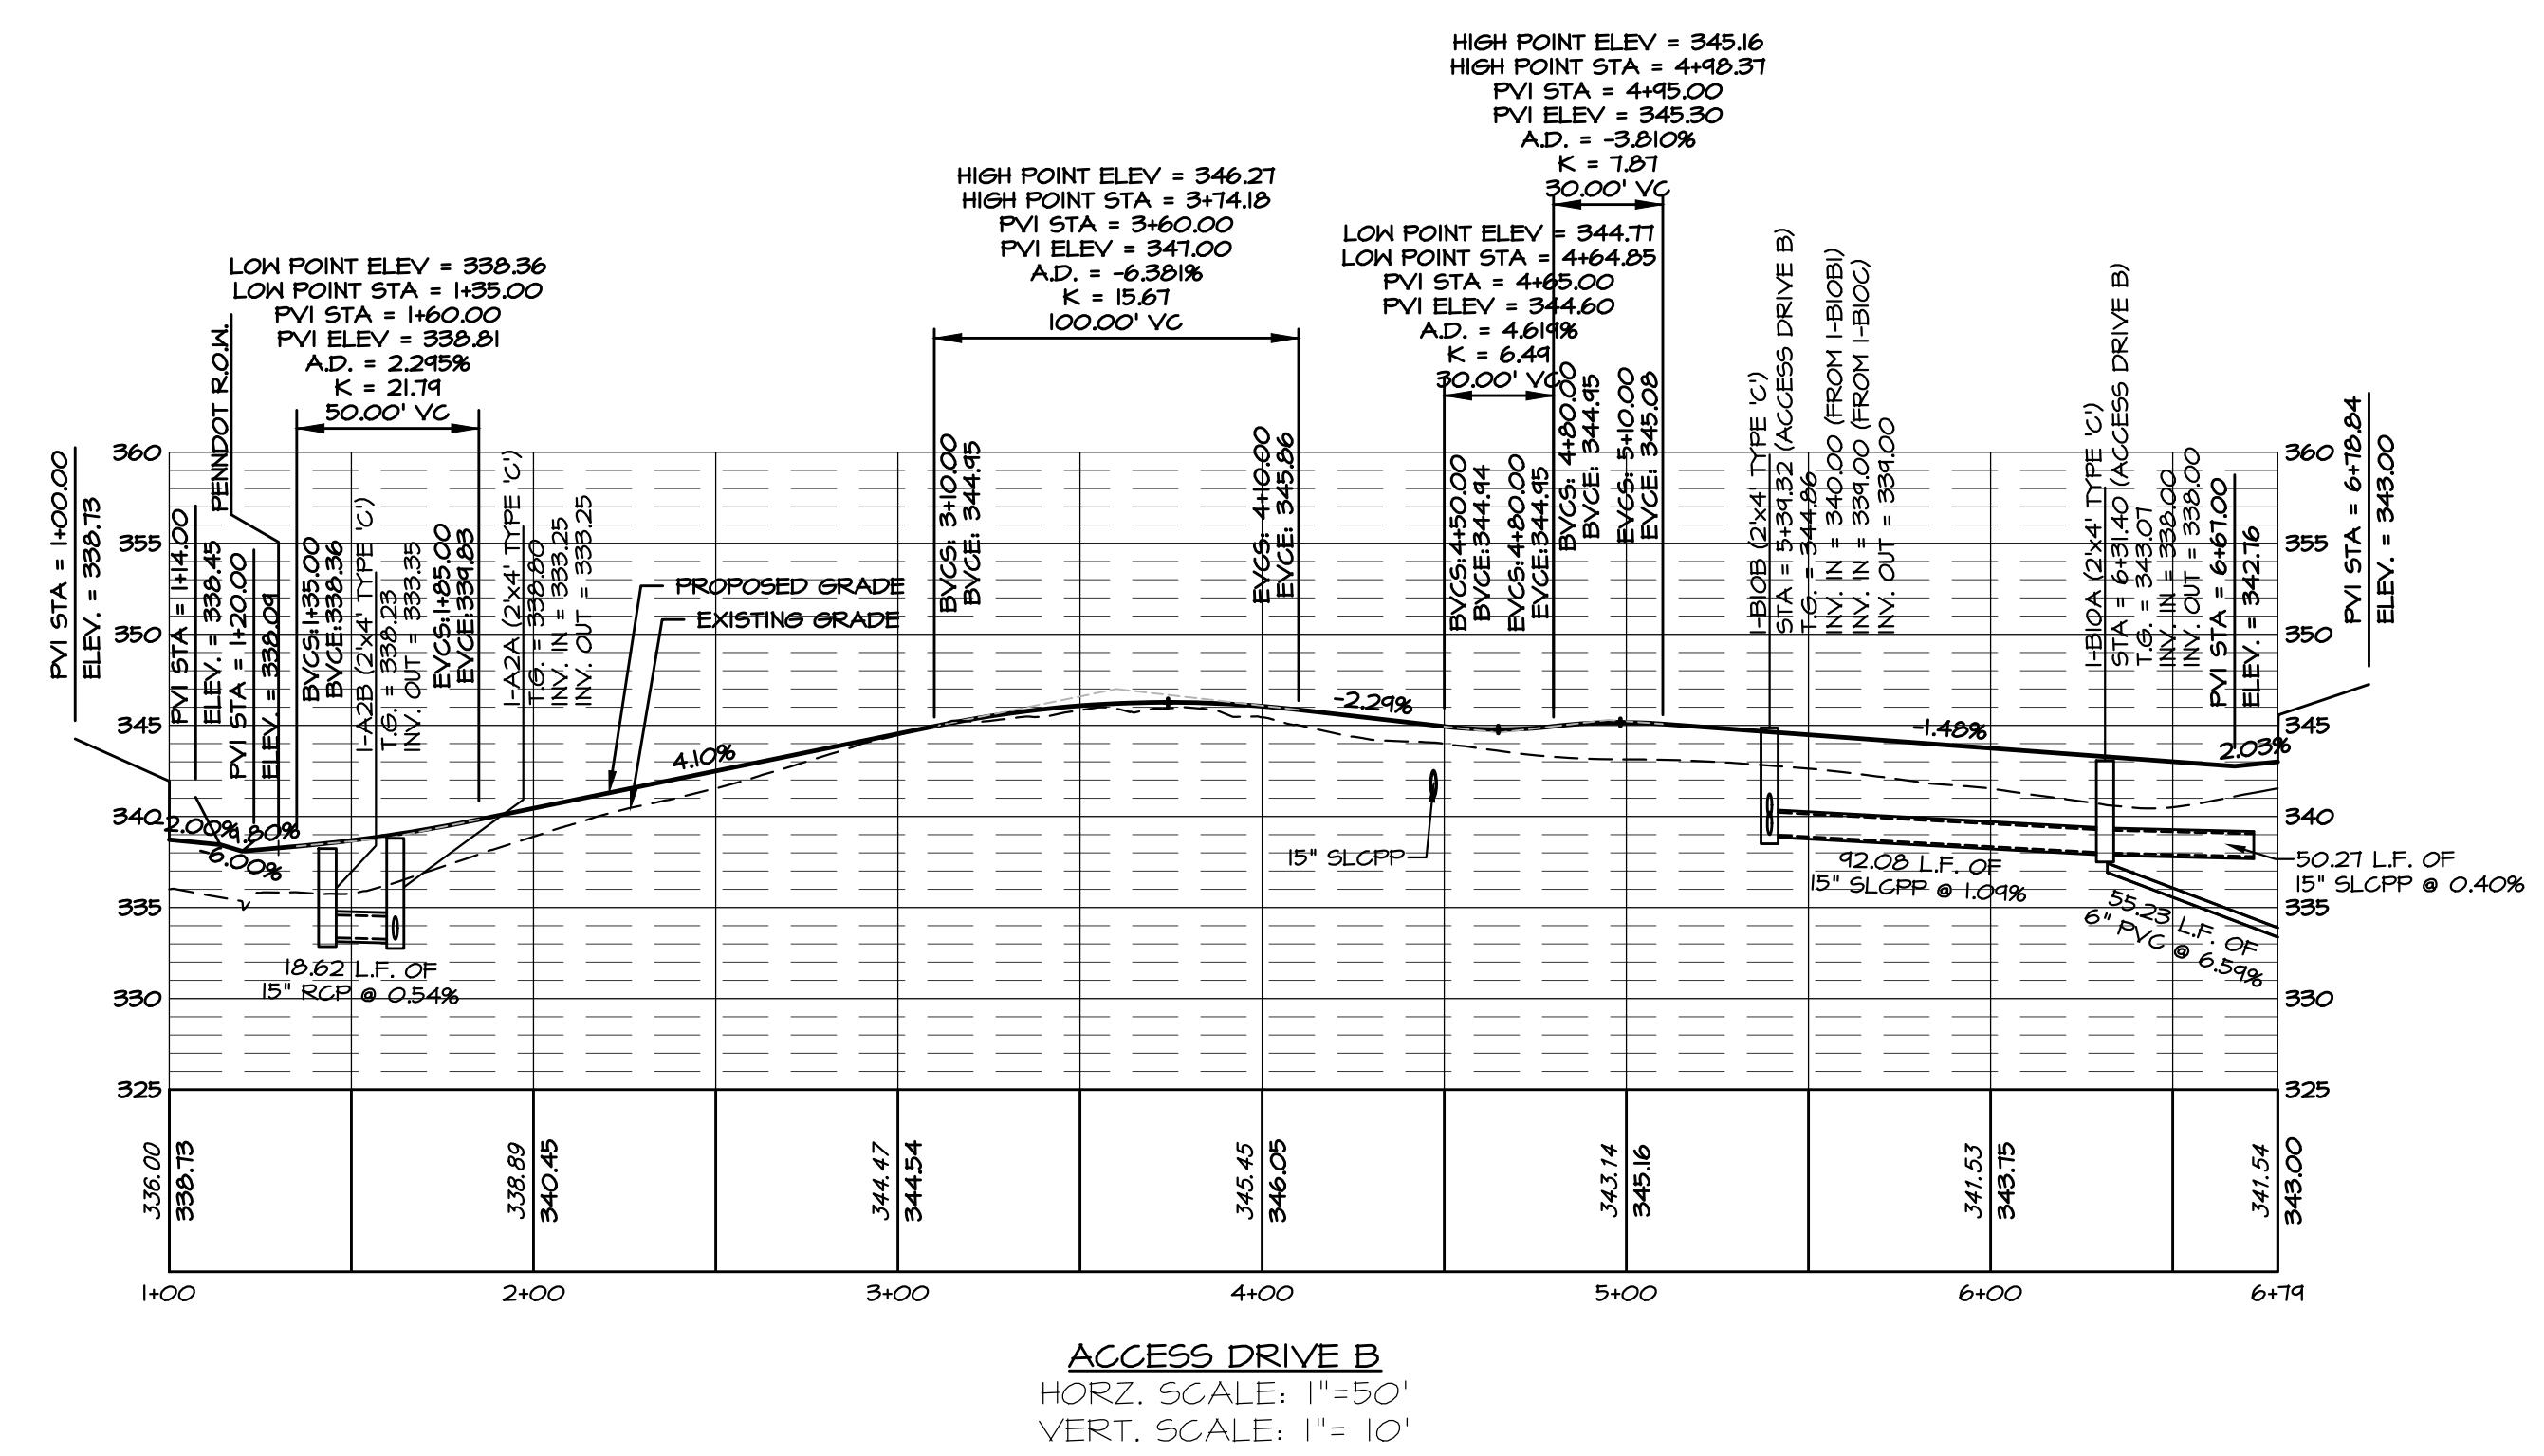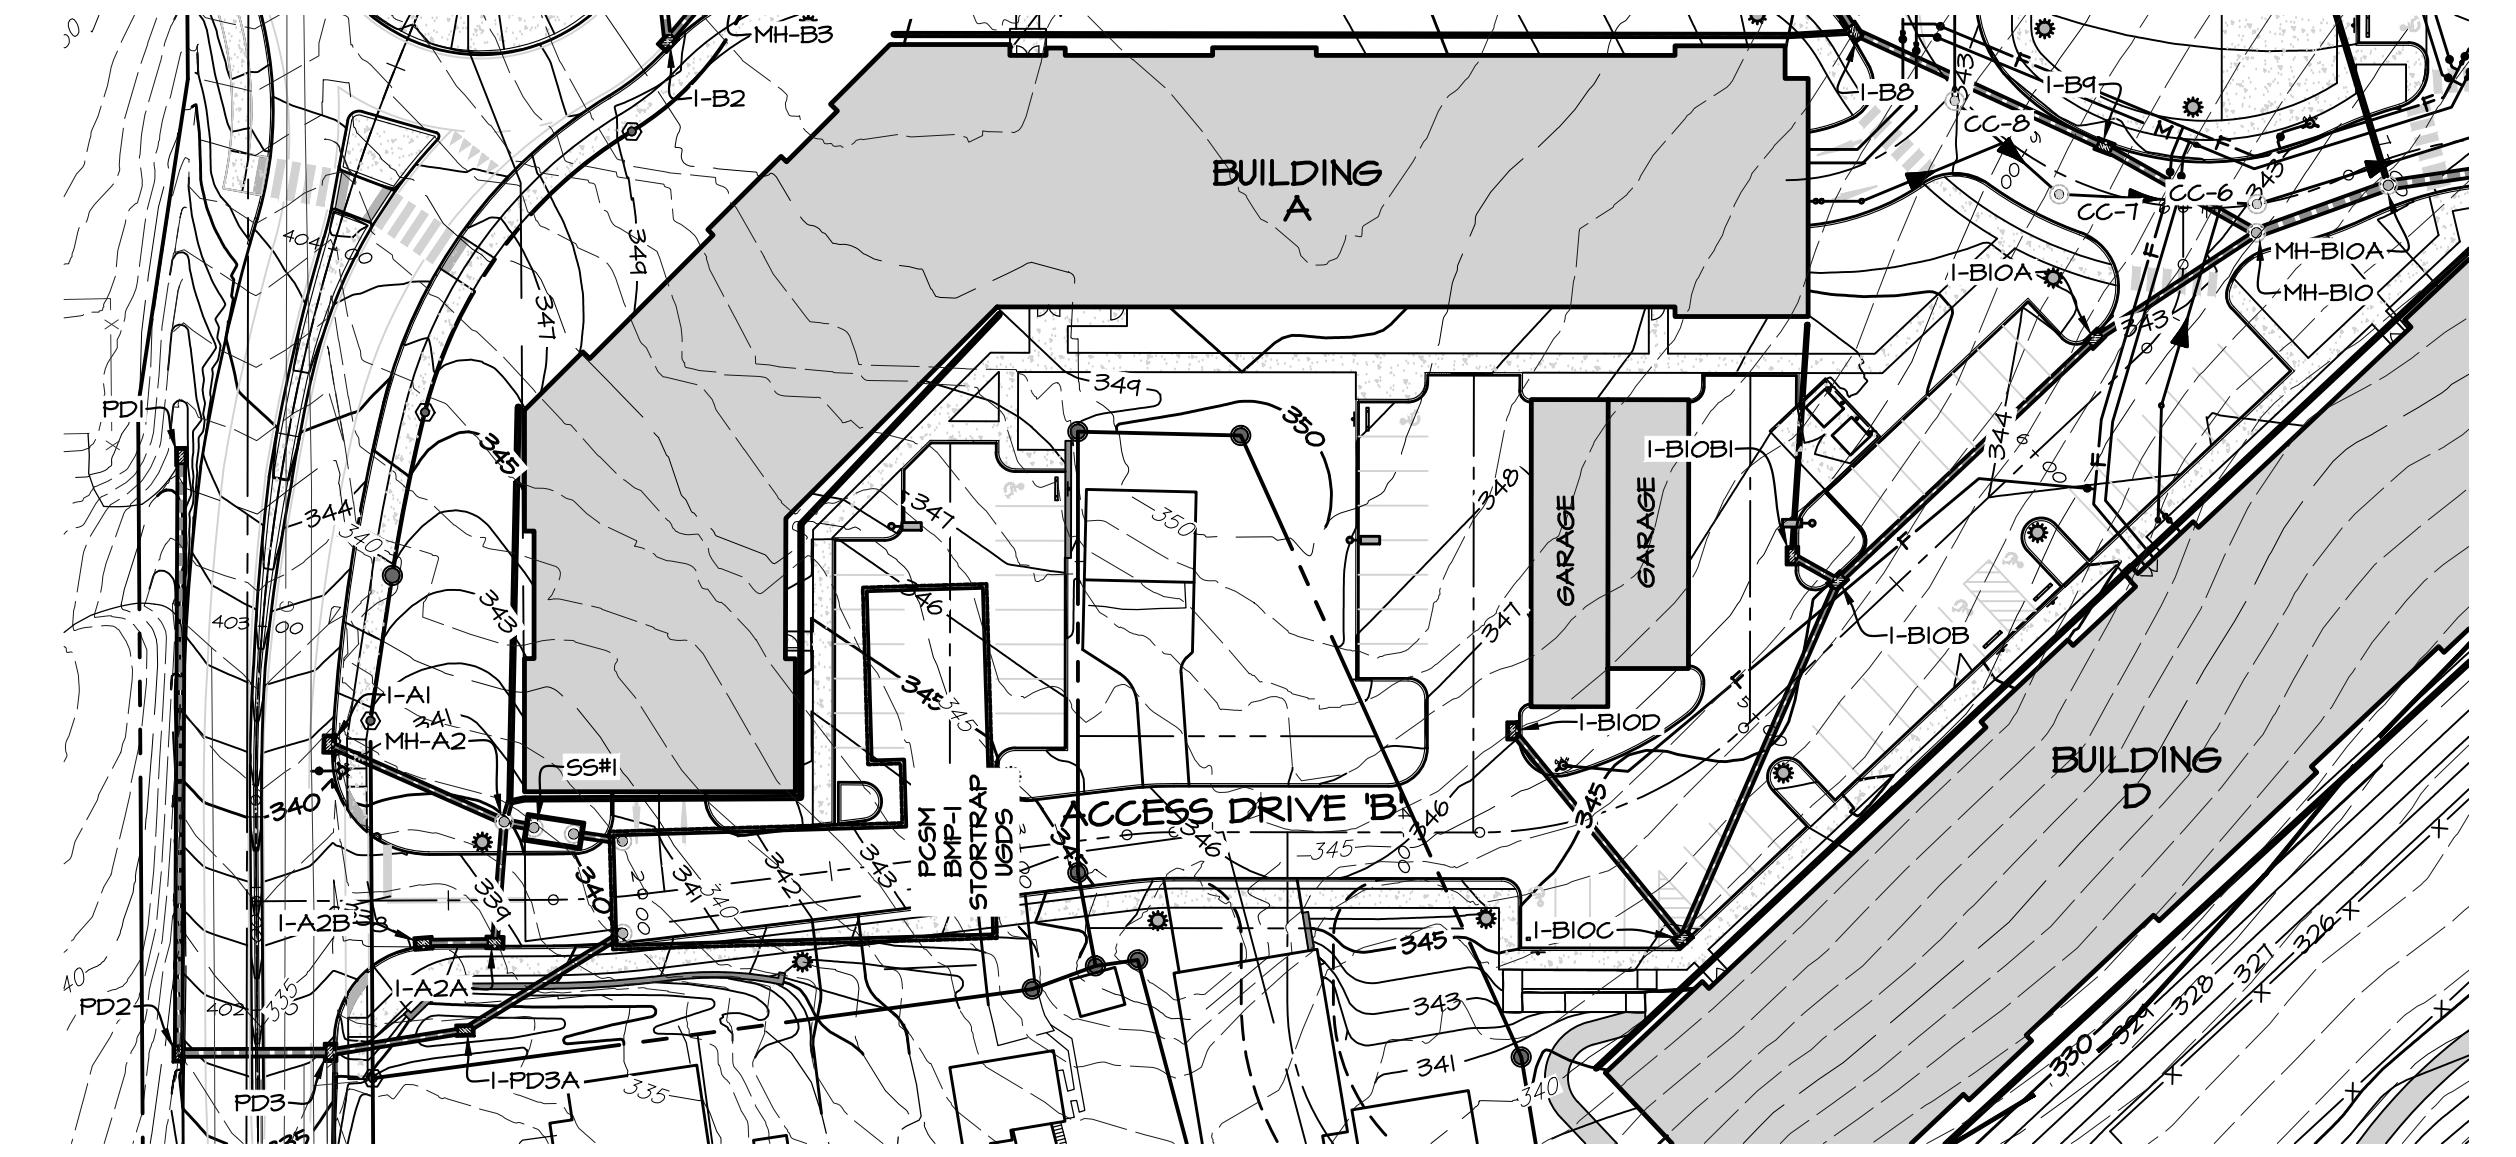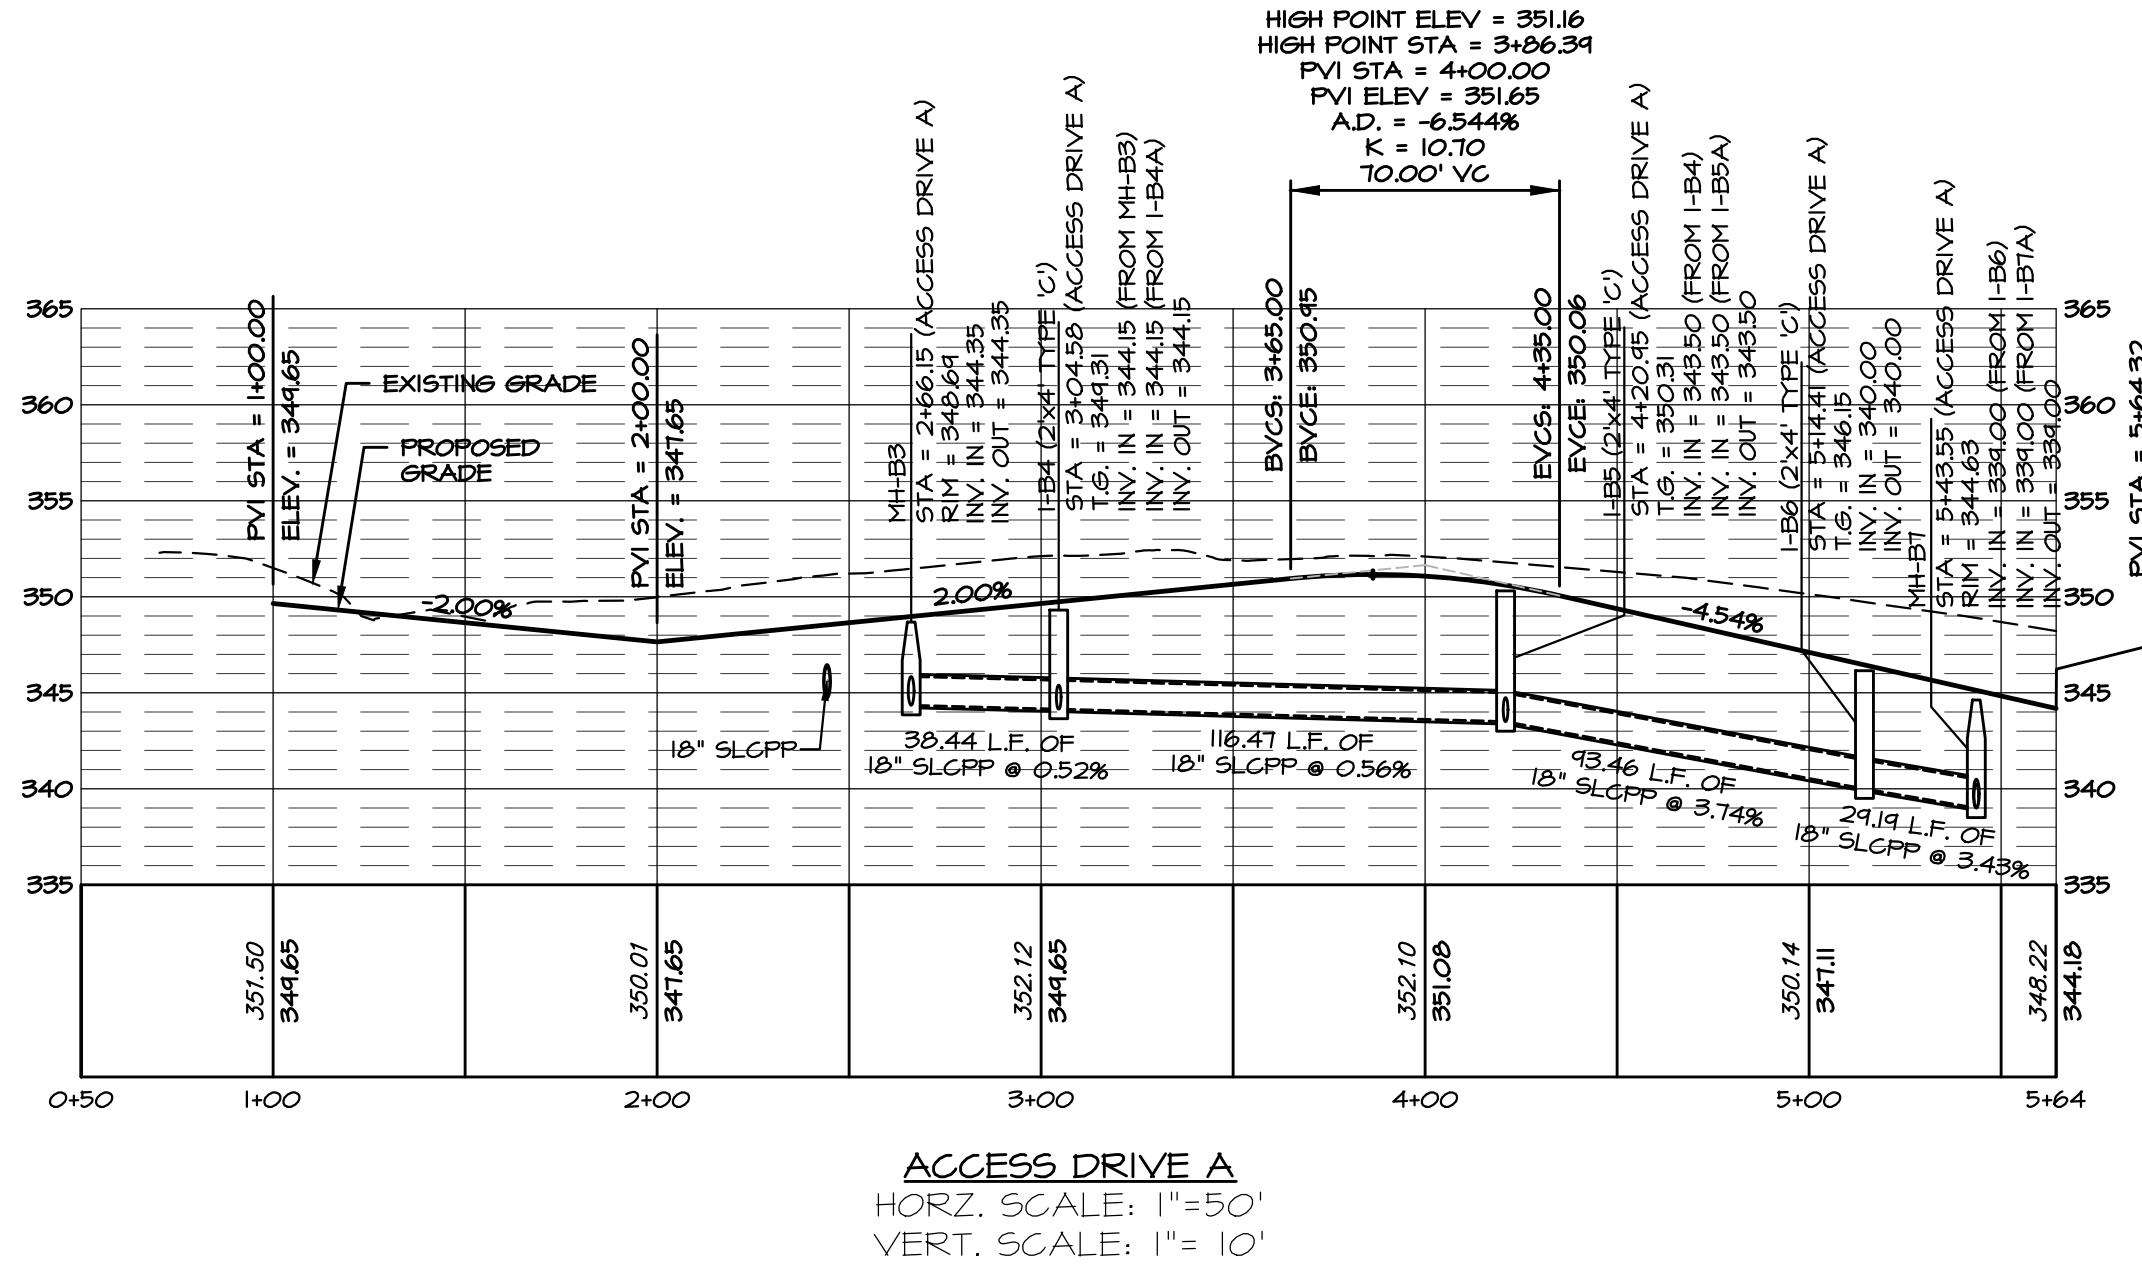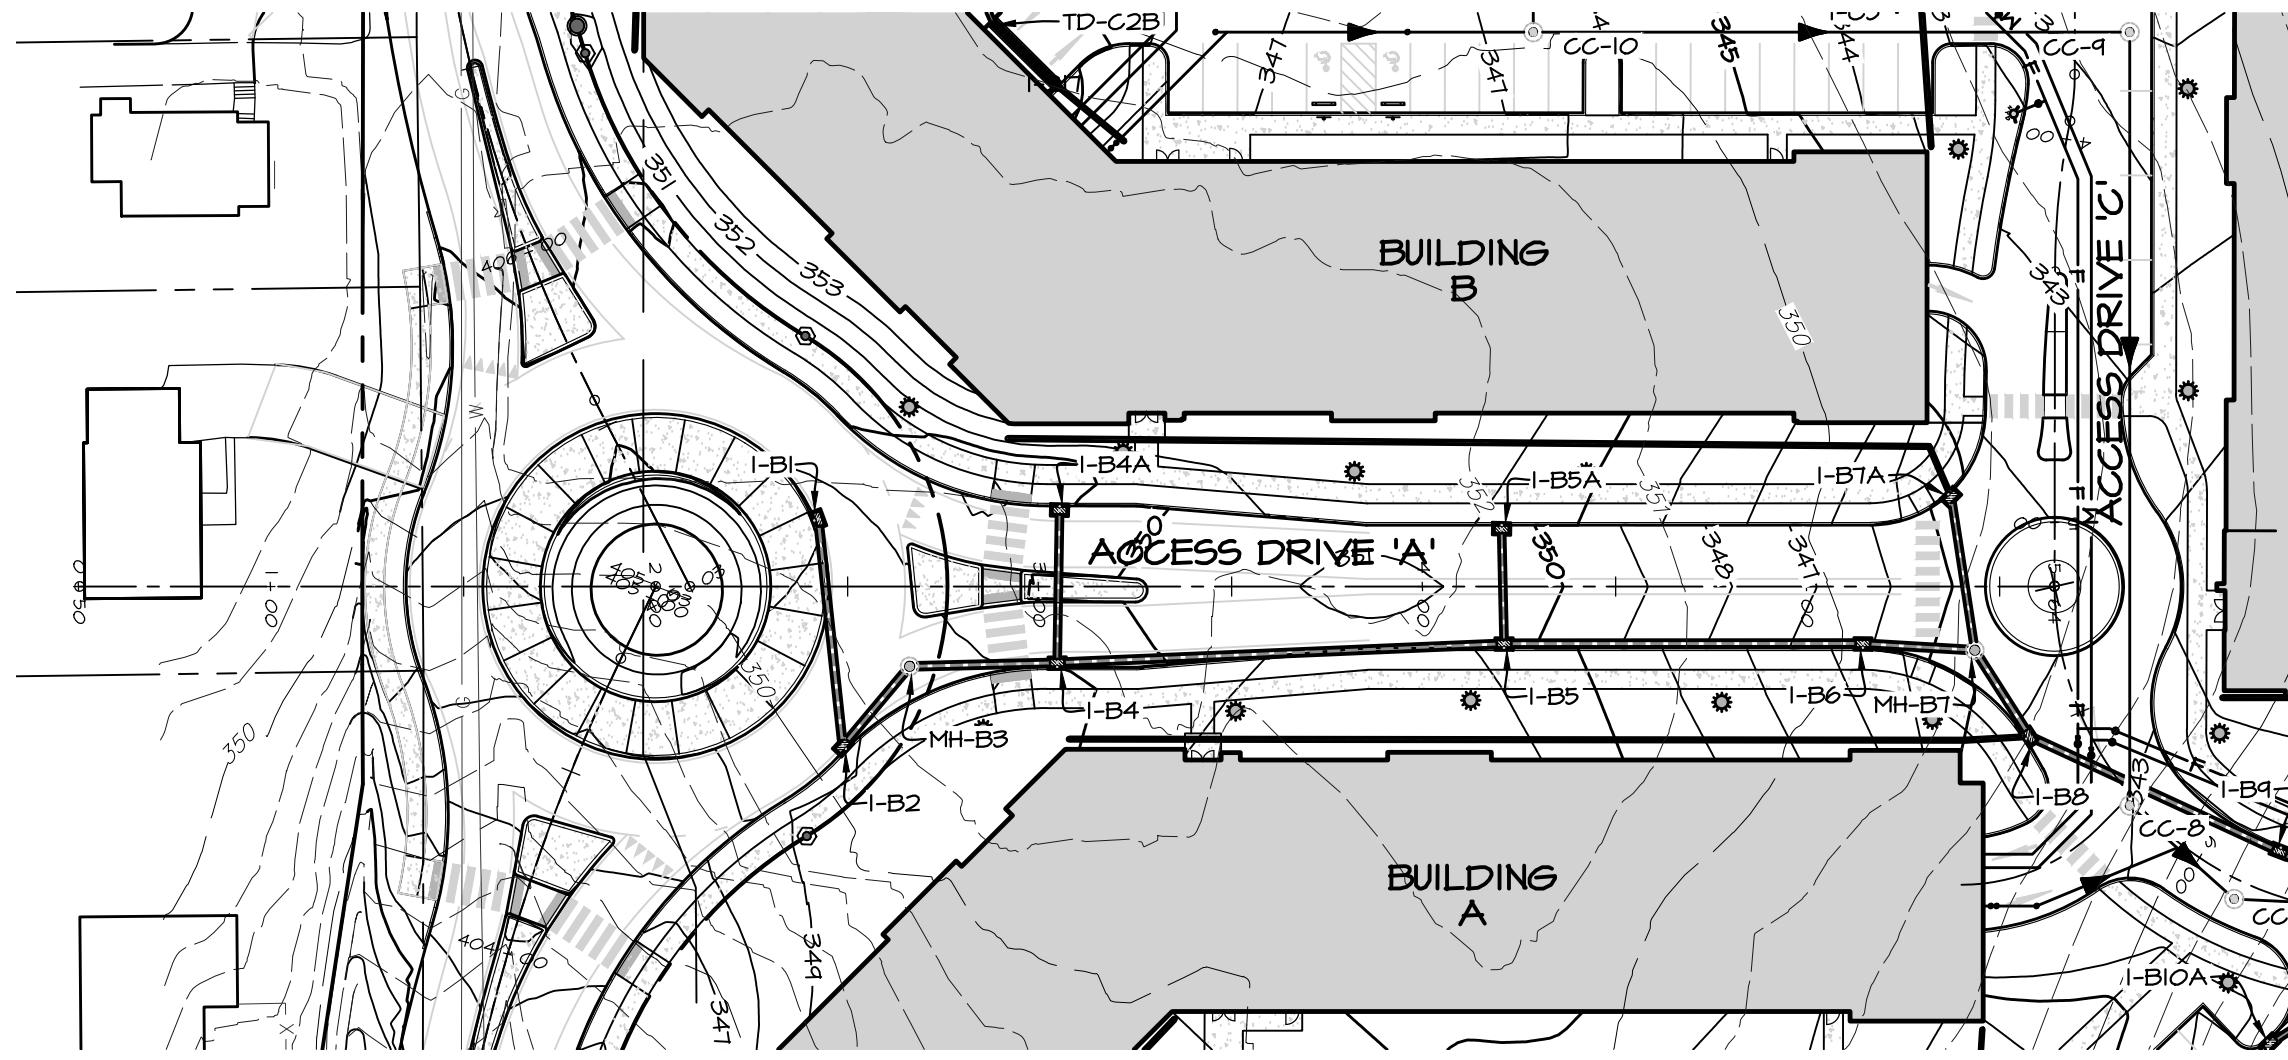
**NOTES**

- CONTRACTOR SHALL FIELD VERIFY LOCATION OF ALL EXISTING UTILITIES PRIOR TO COMMENCEMENT OF EXCAVATION. ADJUST UTILITIES AS REQUIRED TO ALLOW INSTALLATION OF STORMWATER CONVEYANCE SYSTEM. COORDINATE ALL WORK WITH UTILITY PROVIDERS AND THE OWNER.
- INLETS SHALL INCLUDE A 2-INCH T.G. SUMP WHERE INDICATED IN THE PROFILES (IF APPLICABLE). PLEASE NOTE THE T.G. ELEVATION VALUES LABELED IN THE PROFILES ALREADY REFLECT THE 2" DEPRESSION AND C.I.T SHOULD NOT BE SUBTRACTED FROM THE T.G. VALUE.
- ALL SMOOTH LINED CORRUGATED POLYETHYLENE STORM PIPE (SLCPP) SHALL BE PROVIDED WITH INTEGRAL BELL AND SPIGOT JOINT MEETING THE REQUIREMENTS OF AASHTO M252, AASHTO M244, OR ASTM F2306. THE JOINT SHALL BE WATERTIGHT ACCORDING TO THE REQUIREMENTS OF ASTM D3212. GASKETS SHALL MEET THE REQUIREMENTS OF ASTM F471 AND SHALL BE INSTALLED BY THE PIPE MANUFACTURER AND COVERED WITH A REMOVABLE, PROTECTIVE WRAP TO ENSURE THE GASKET IS FREE OF DEBRIS. ALL REINFORCED CONCRETE STORM PIPE (RCP) SHALL BE PROVIDED WITH WATERTIGHT O-RING GASKETS.
- CONTRACTOR SHALL PROVIDE MINIMUM VERTICAL SEPARATION OF 12" BETWEEN EXISTING OR PROPOSED WATER/SEWER LINES AND STORM PIPES / INLETS.
- PIPE INTERFACE WITH WALL SHALL BE INCORPORATED BY WALL DESIGN (BY OTHERS) AND COORDINATED BY CONTRACTOR DURING CONSTRUCTION.
- ALL WORK IN PENNDOT RIGHT-OF-WAY SUBJECT TO HIGHWAY OCCUPANCY PERMIT APPROVAL. SEE APPROVED HIGHWAY OCCUPANCY PERMIT PLAN FOR DESIGN / CONSTRUCTION IN THE PENNDOT RIGHT-OF-WAY.

SCALE IN FEET: 1" = 50'  
0 25 50 100 150


REVISIONS PER:	DATE:	BY:
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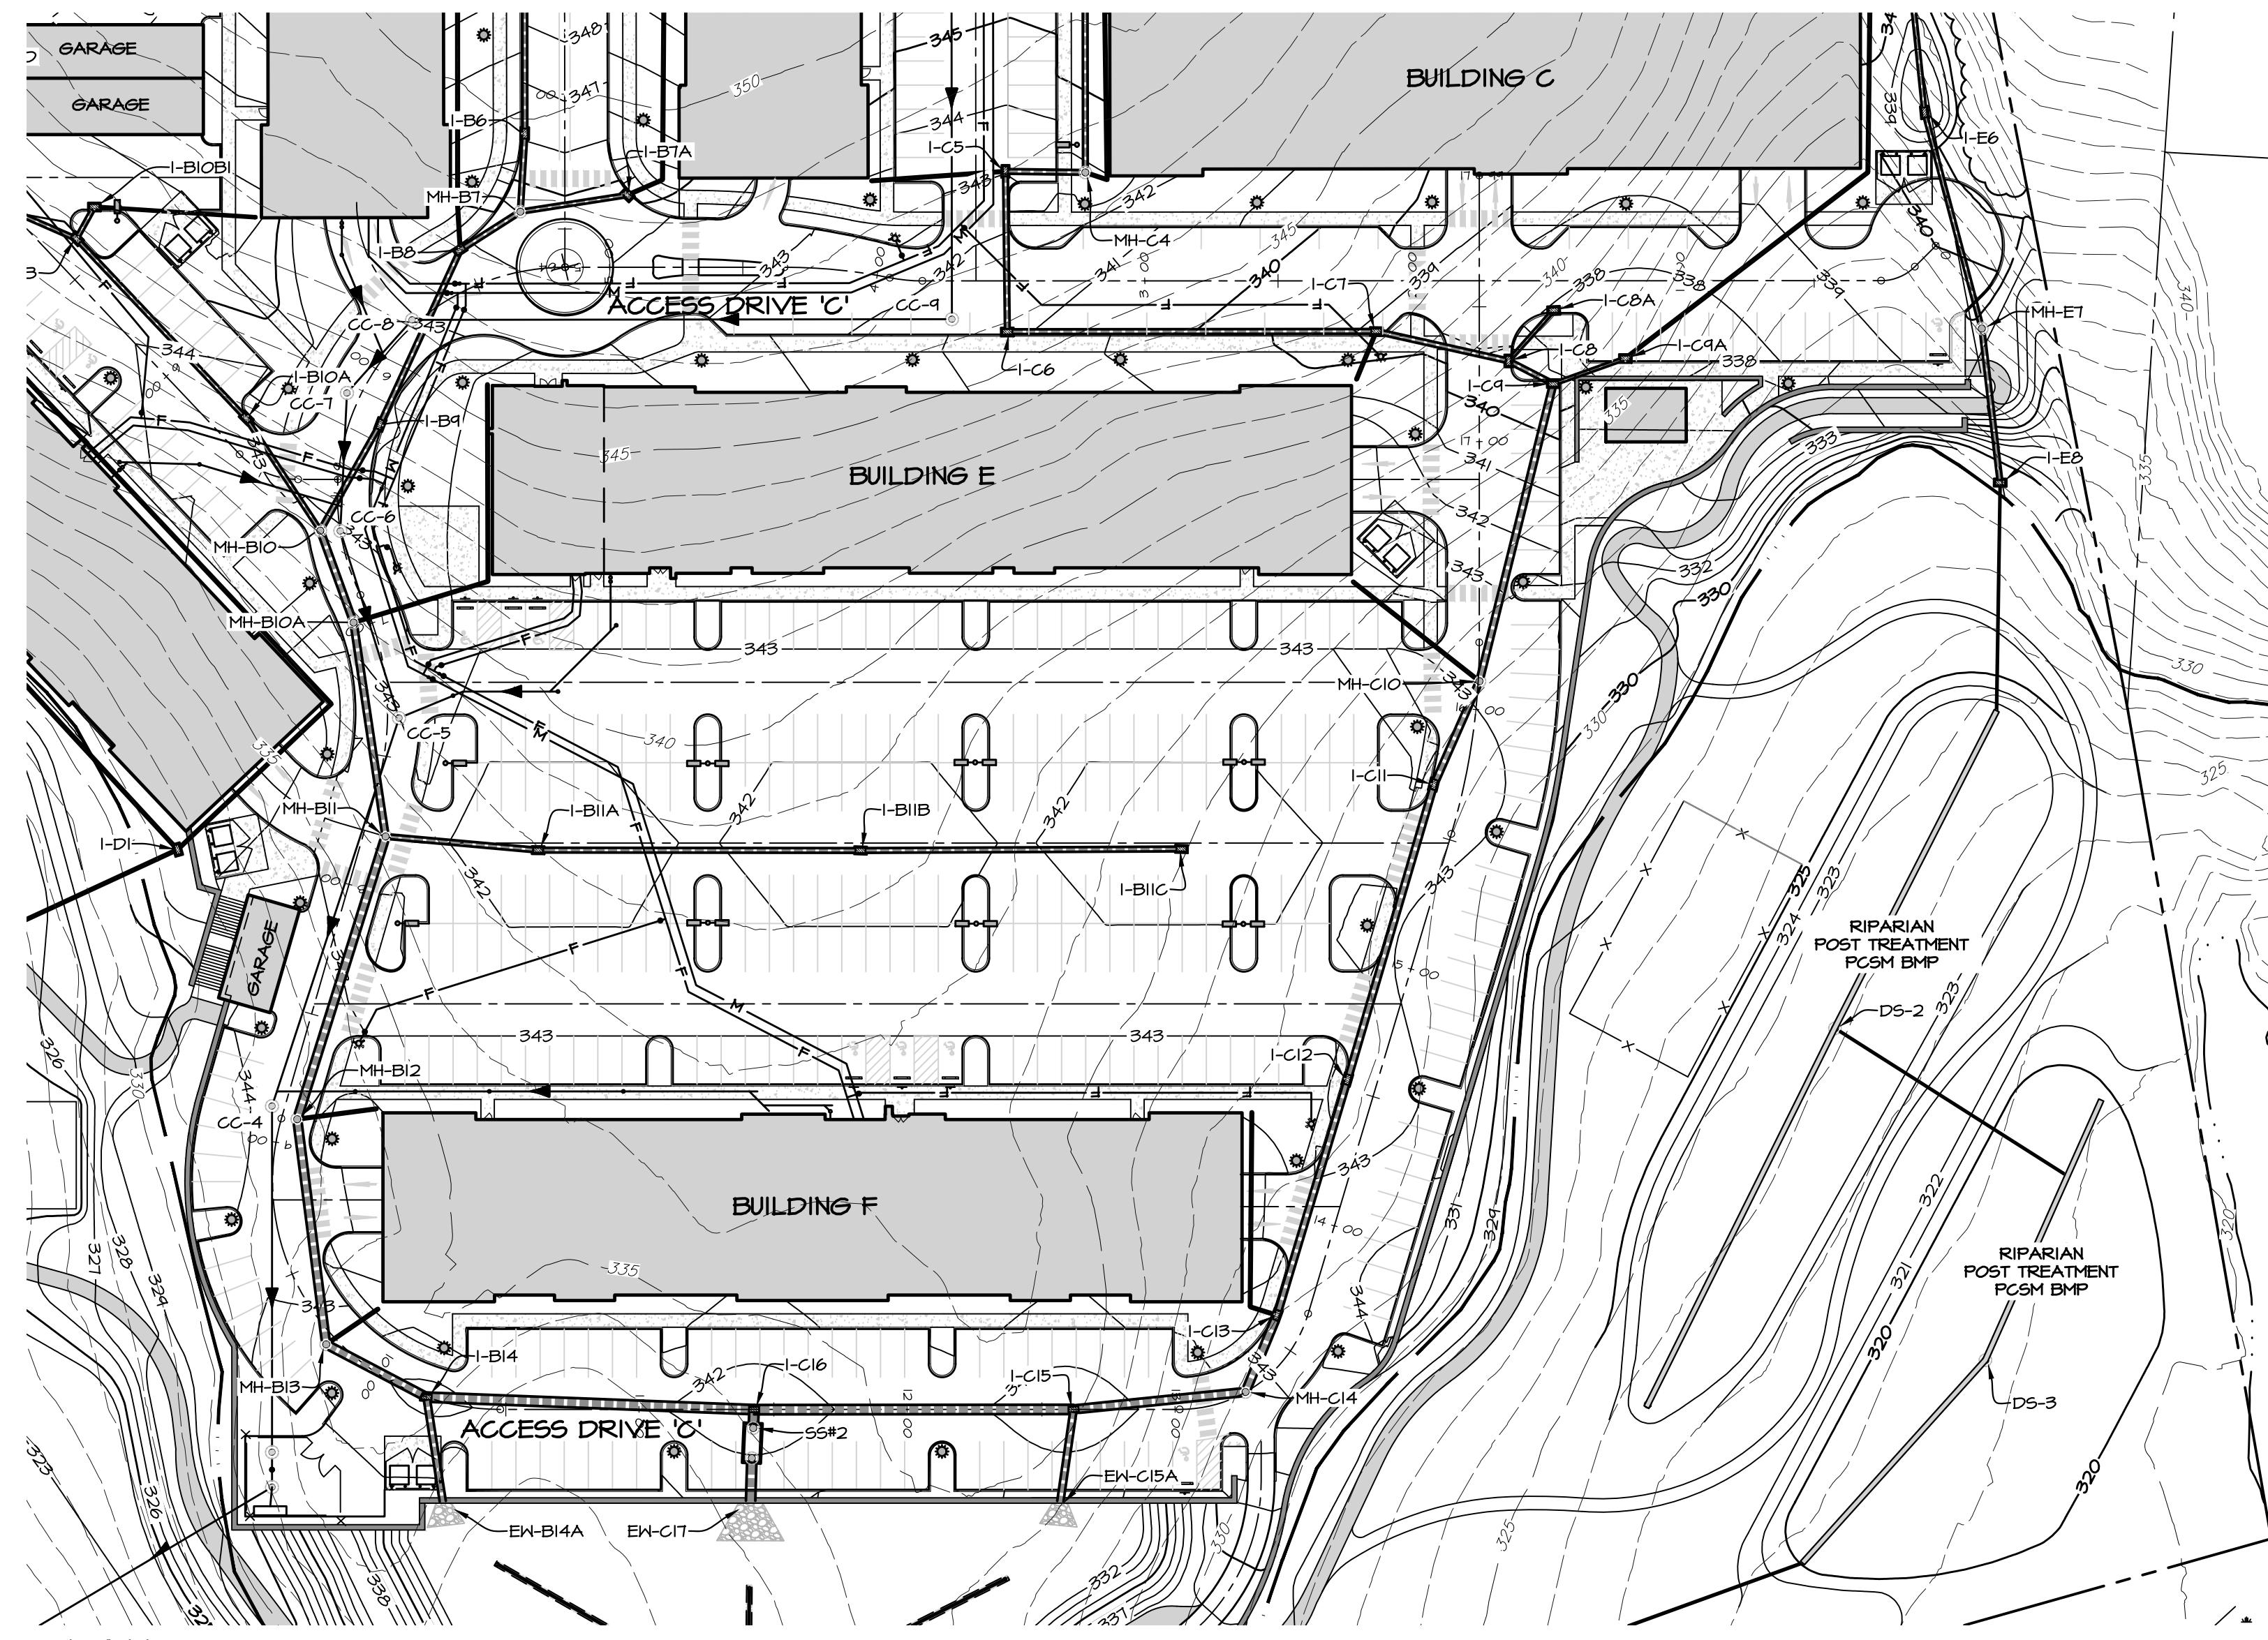
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LITITZ, PA 17543  
(717) 626-7271  
elagroup.com

CONDITIONAL USE PLAN SUBJECT: ACCESS DRIVE PROFILES		
FOR CHIQUES CROSSING RAPHO TOWNSHIP, LANCASTER COUNTY, PENNSYLVANIA		
CLIENT: VISTABLOCK, LLC 150 FARMINGTON LANE LANCASTER, PA 17601 717-682-8775		

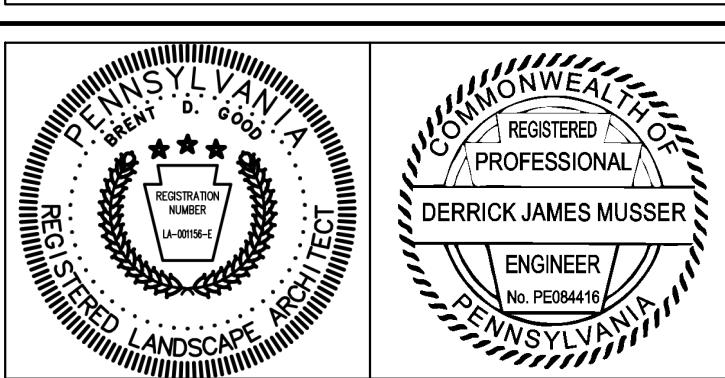MANAGER:	BDG	DATE:	JAN. 5, 2024
DESIGNER:	DJM	PROJECT NO.	1212-002
DRAWN BY:	BLM	SCALE:	AS SHOWN




ACCESS DRIVE

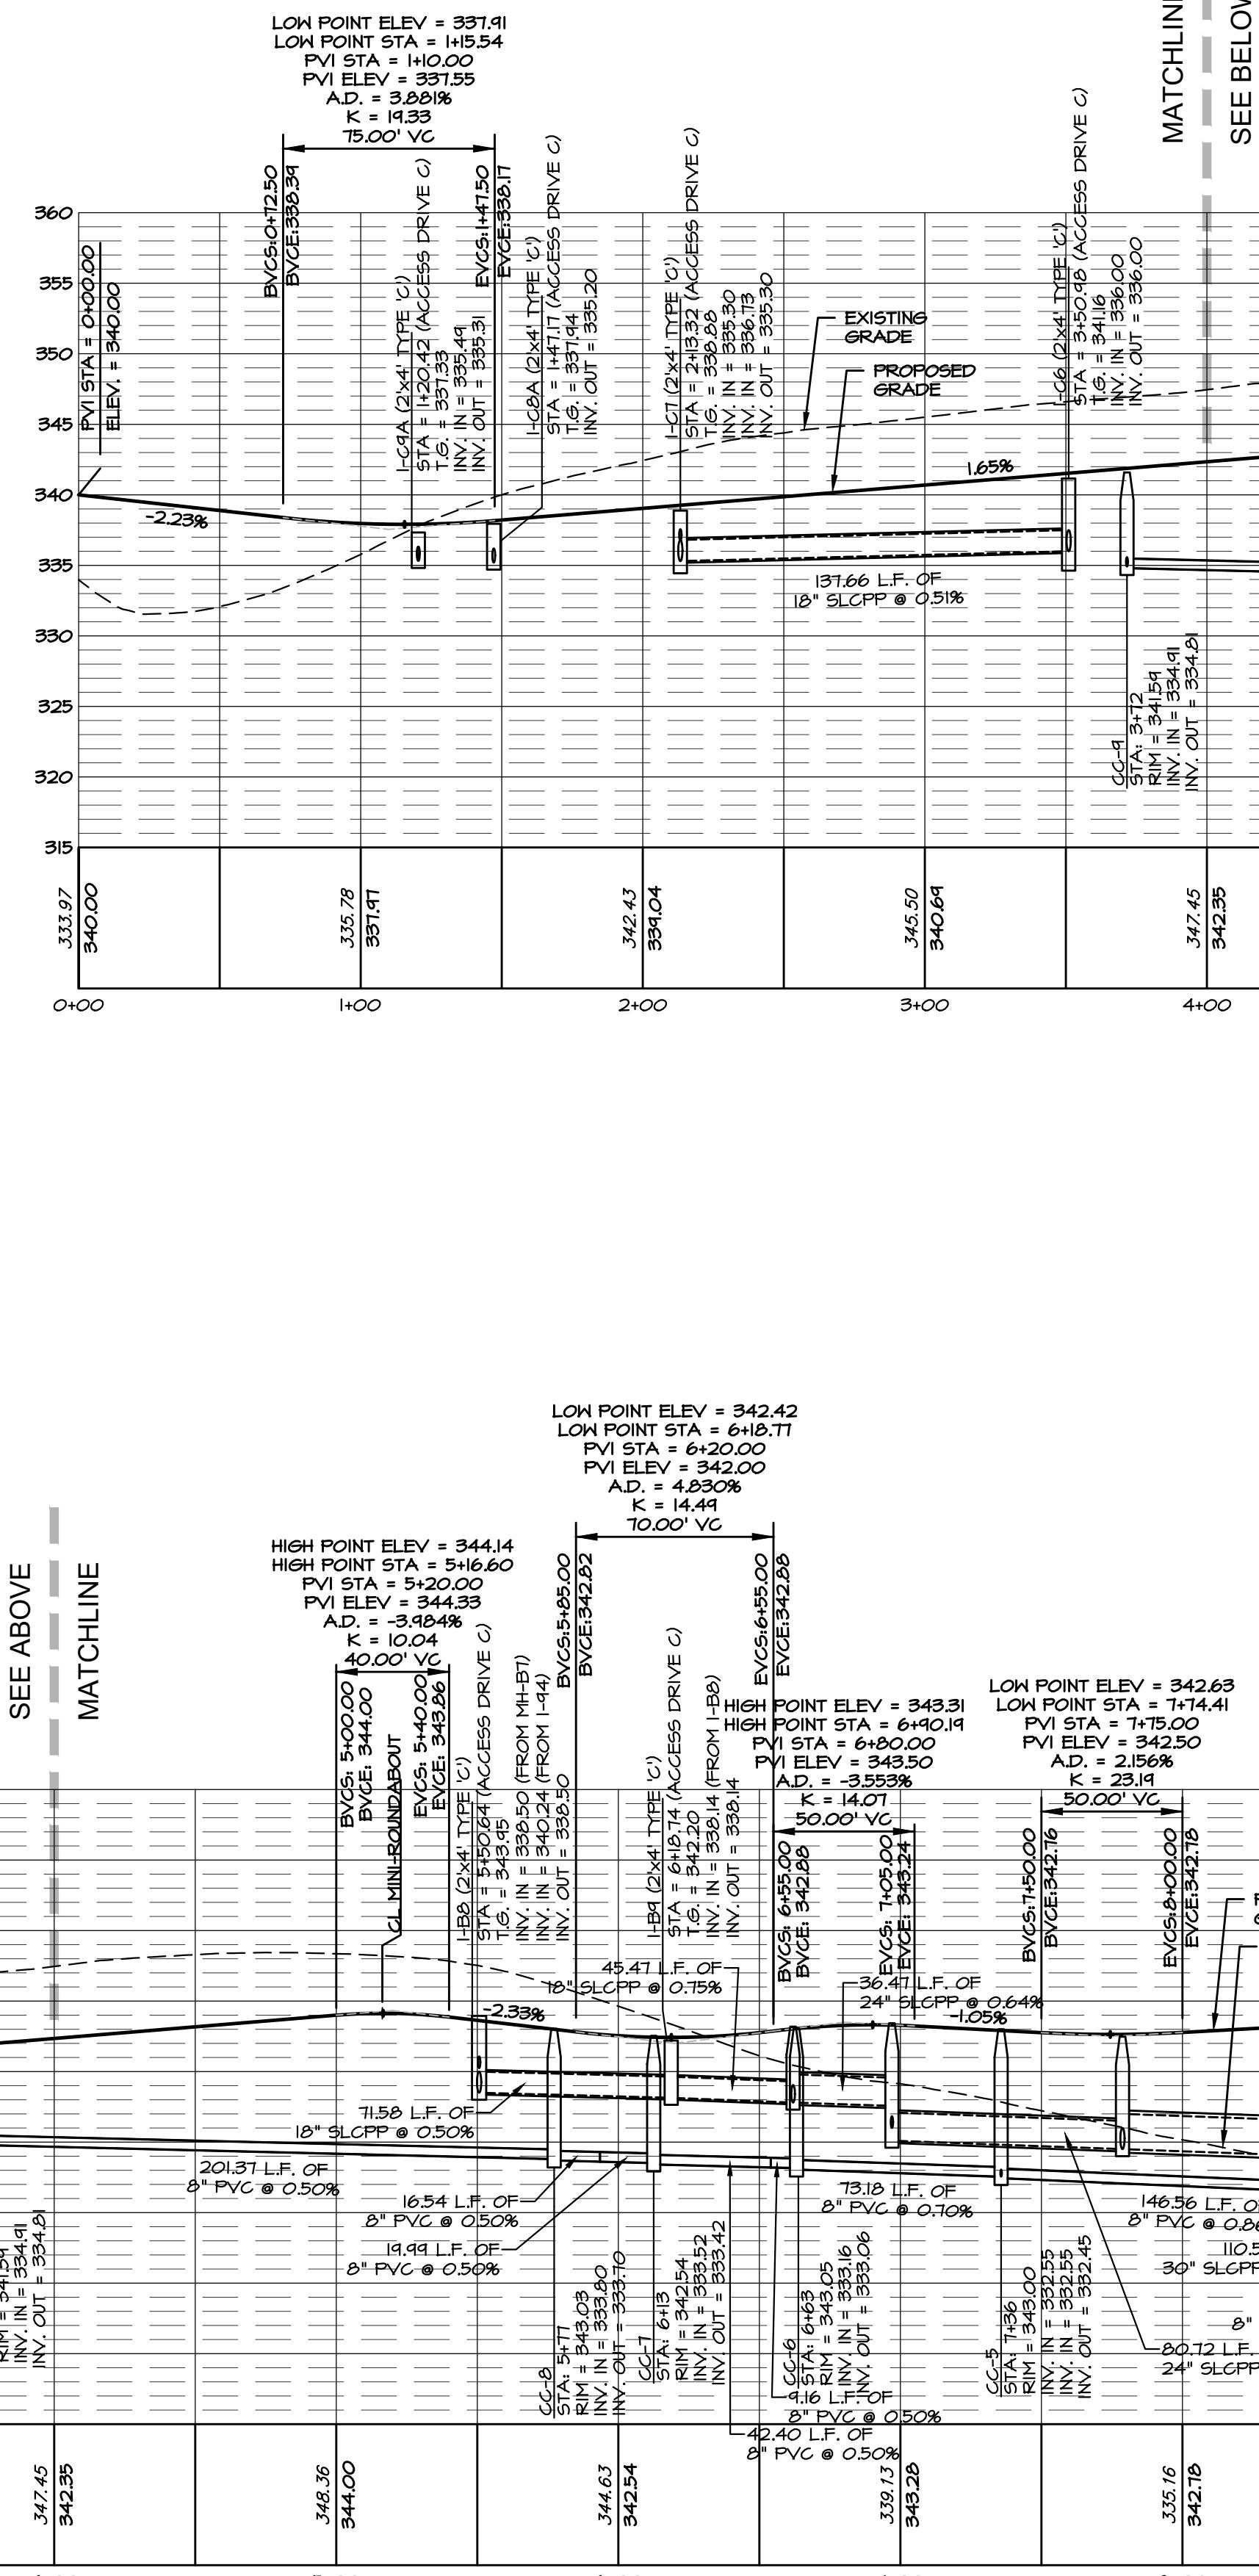

## NOTES

- I. CONTRACTOR SHALL FIELD VERIFY LOCATION OF ALL EXISTING UTILITIES PRIOR TO COMMENCEMENT OF EXCAVATION. ADJUST UTILITIES AS REQUIRED TO ALLOW INSTALLATION OF STORMWATER CONVEYANCE SYSTEM. COORDINATE ALL WORK WITH UTILITY PROVIDERS AND THE OWNER.
  2. INLETS SHALL INCLUDE A 2-INCH T.G. SUMP WHERE INDICATED IN THE PROFILES (IF APPLICABLE). PLEASE NOTE THE T.G. ELEVATION VALUES LABELED IN THE PROFILES ALREADY REFLECT THE 2" DEPRESSION AND 0.17 SHOULD NOT BE SUBTRACTED FROM THE T.G. VALUE.
  3. ALL SMOOTH LINED CORRUGATED POLYETHYLENE STORM PIPE (SLCPP) SHALL BE PROVIDED WITH INTEGRAL BELL AND SPIGOT JOINT MEETING THE REQUIREMENTS OF AASHTO M252, AASHTO M294, OR ASTM F2306. THE JOINT SHALL BE WATERTIGHT ACCORDING TO THE REQUIREMENTS OF ASTM D3212. GASKETS SHALL MEET THE REQUIREMENTS OF ASTM F471 AND SHALL BE INSTALLED BY THE PIPE MANUFACTURER AND COVERED WITH A REMOVABLE, PROTECTIVE WRAP TO ENSURE THE GASKET IS FREE OF DEBRIS. ALL REINFORCED CONCRETE STORM PIPE (RCP) SHALL BE PROVIDED WITH WATERTIGHT "O" RING GASKETS.
  4. CONTRACTOR SHALL PROVIDE MINIMUM VERTICAL SEPARATION OF 18" BETWEEN EXISTING OR PROPOSED WATER/SEWER LINES AND STORM PIPES / INLETS.
  5. PIPE INTERFACE WITH WALL SHALL BE INCORPORATED BY WALL DESIGN (BY OTHERS) AND COORDINATED BY CONTRACTOR DURING CONSTRUCTION.

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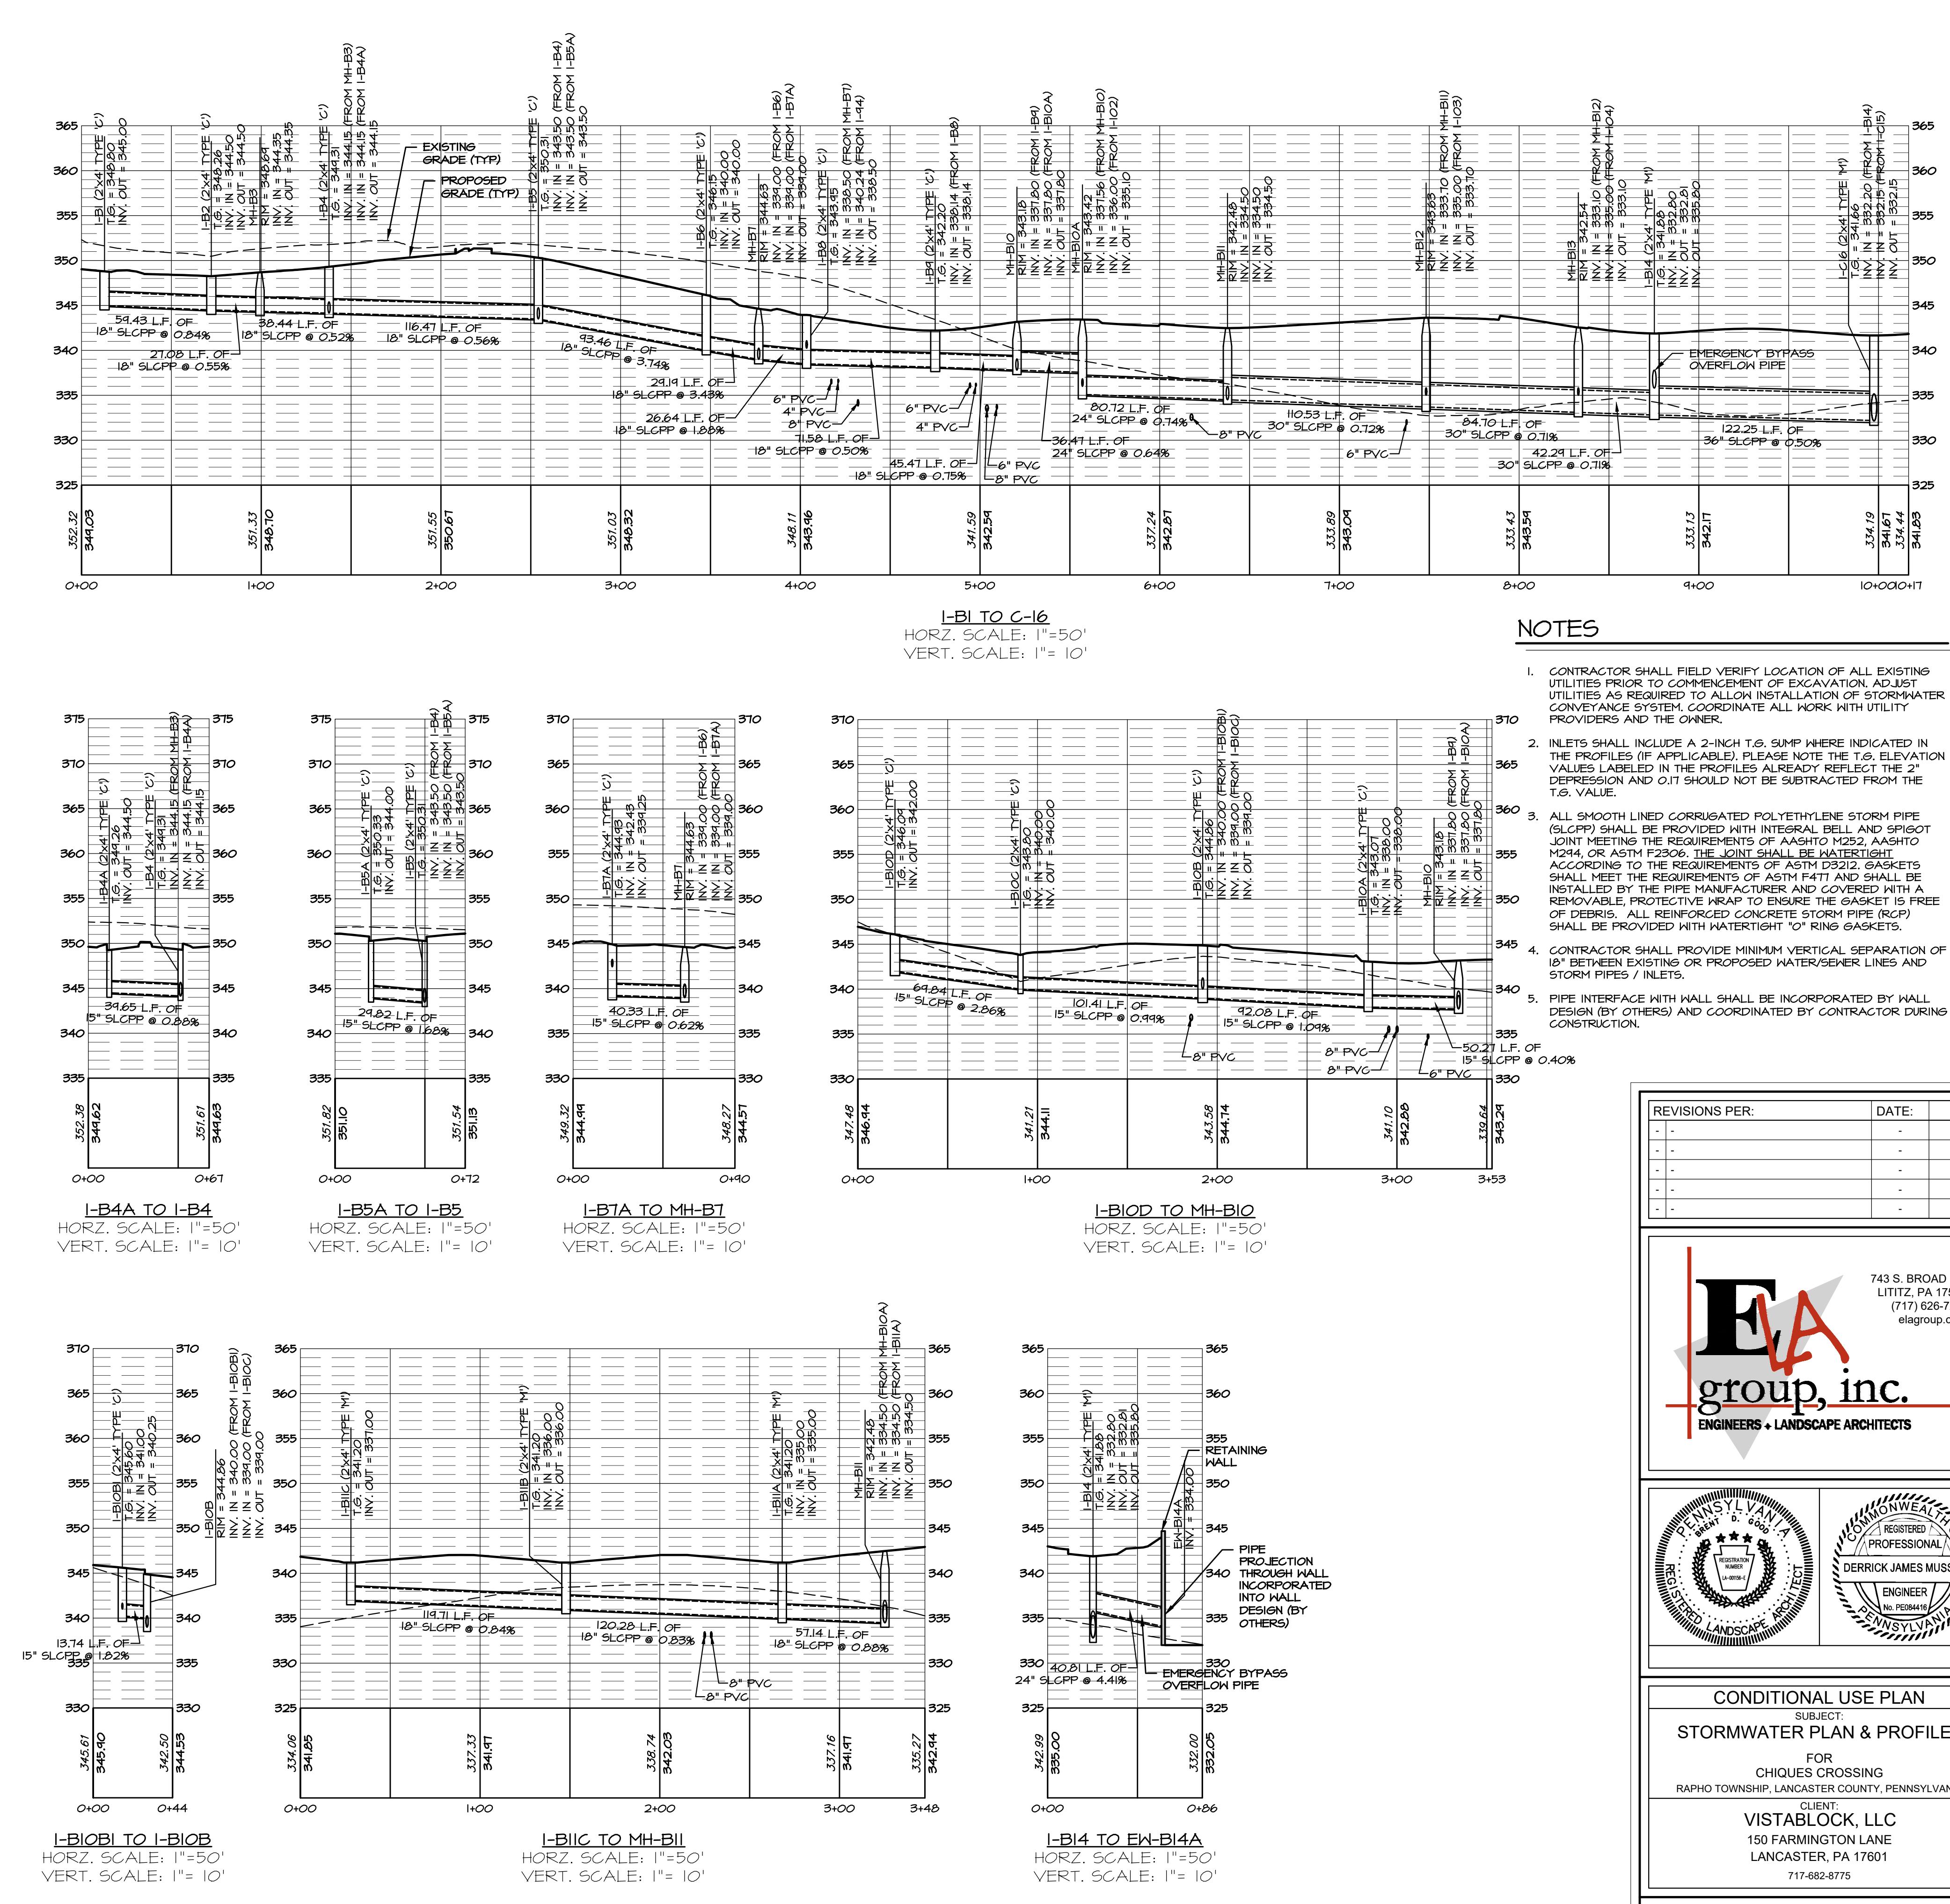
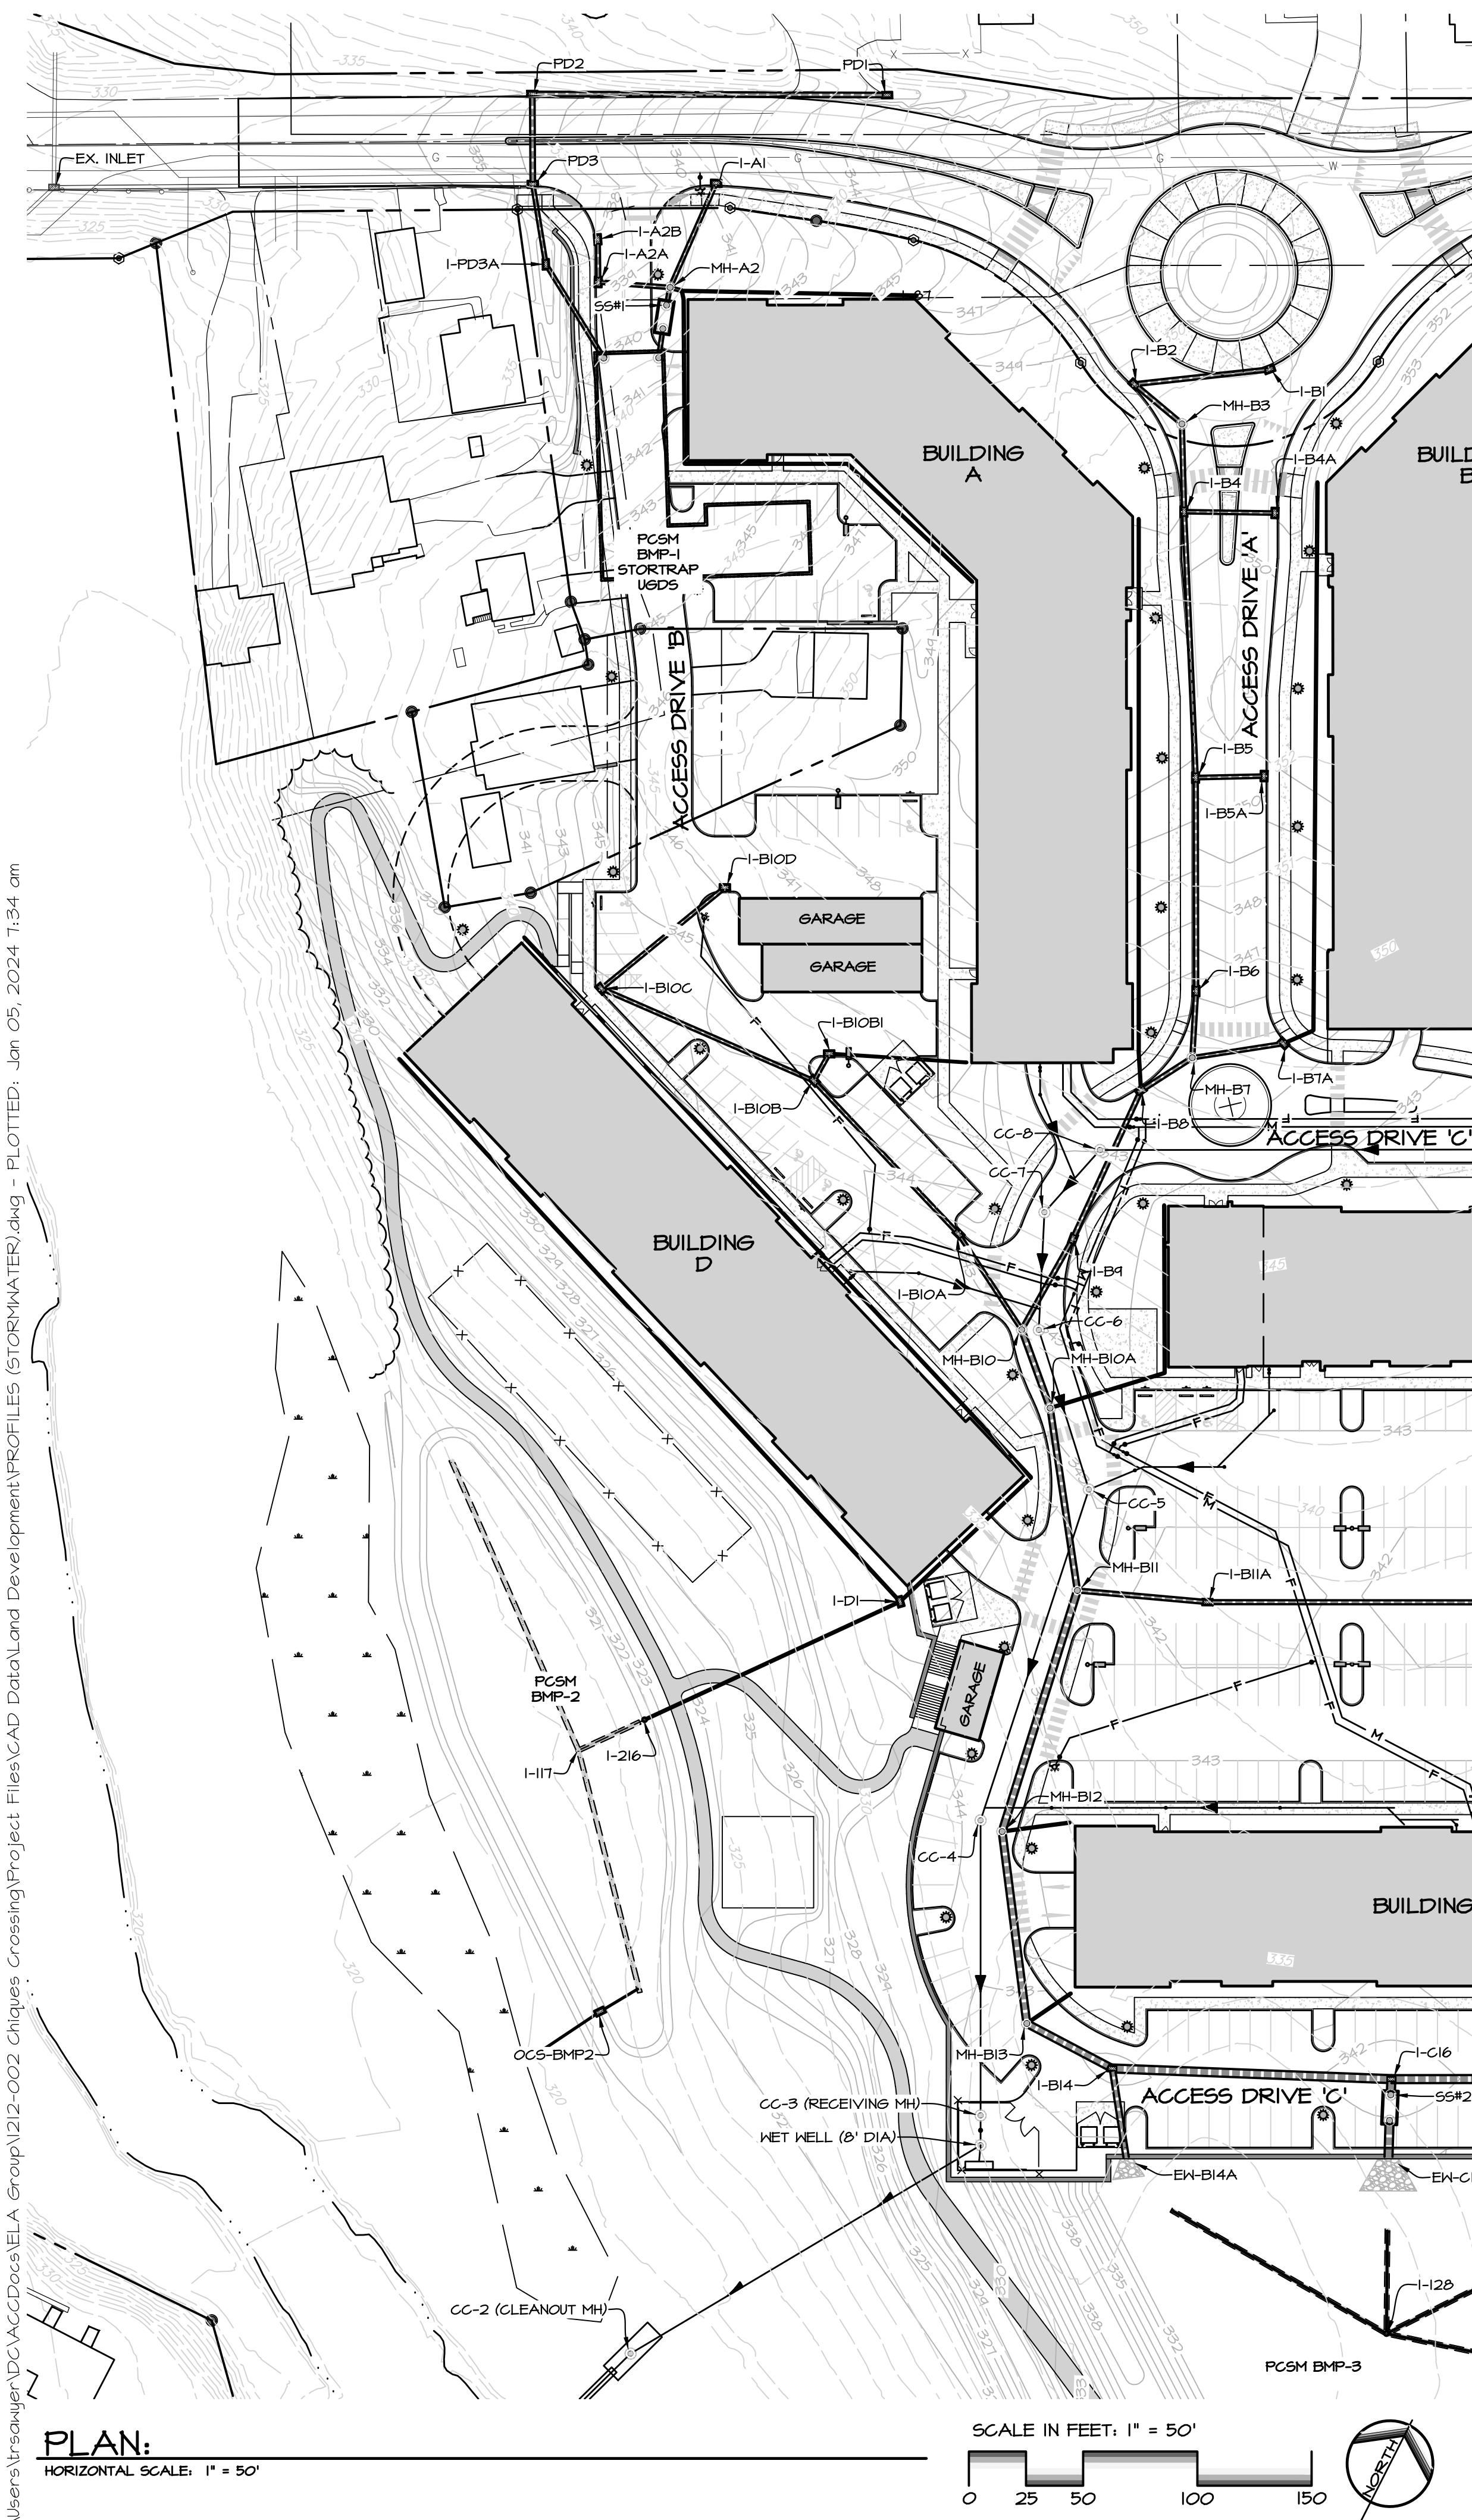


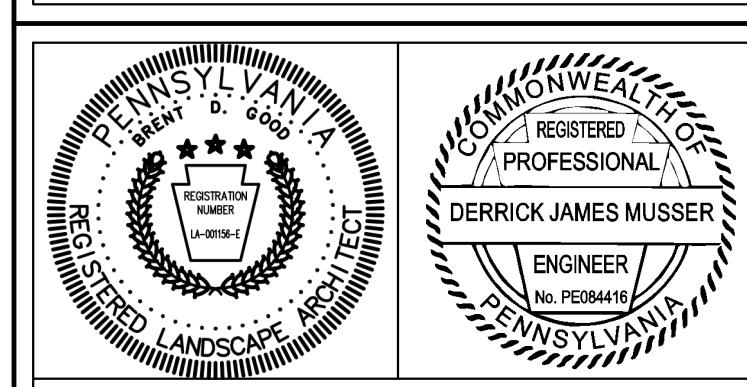**CONDITIONAL USE PLAN**  
**SUBJECT:**  
**ACCESS DRIVE PROFILES**


**FOR**  
**CHIQUES CROSSING**  
**RAPHO TOWNSHIP, LANCASTER COUNTY, PENNSYLVANIA**

**CLIENT:**  
**VISTABLOCK, LLC**

LANCASTER, PA 17601  
717-682-8775





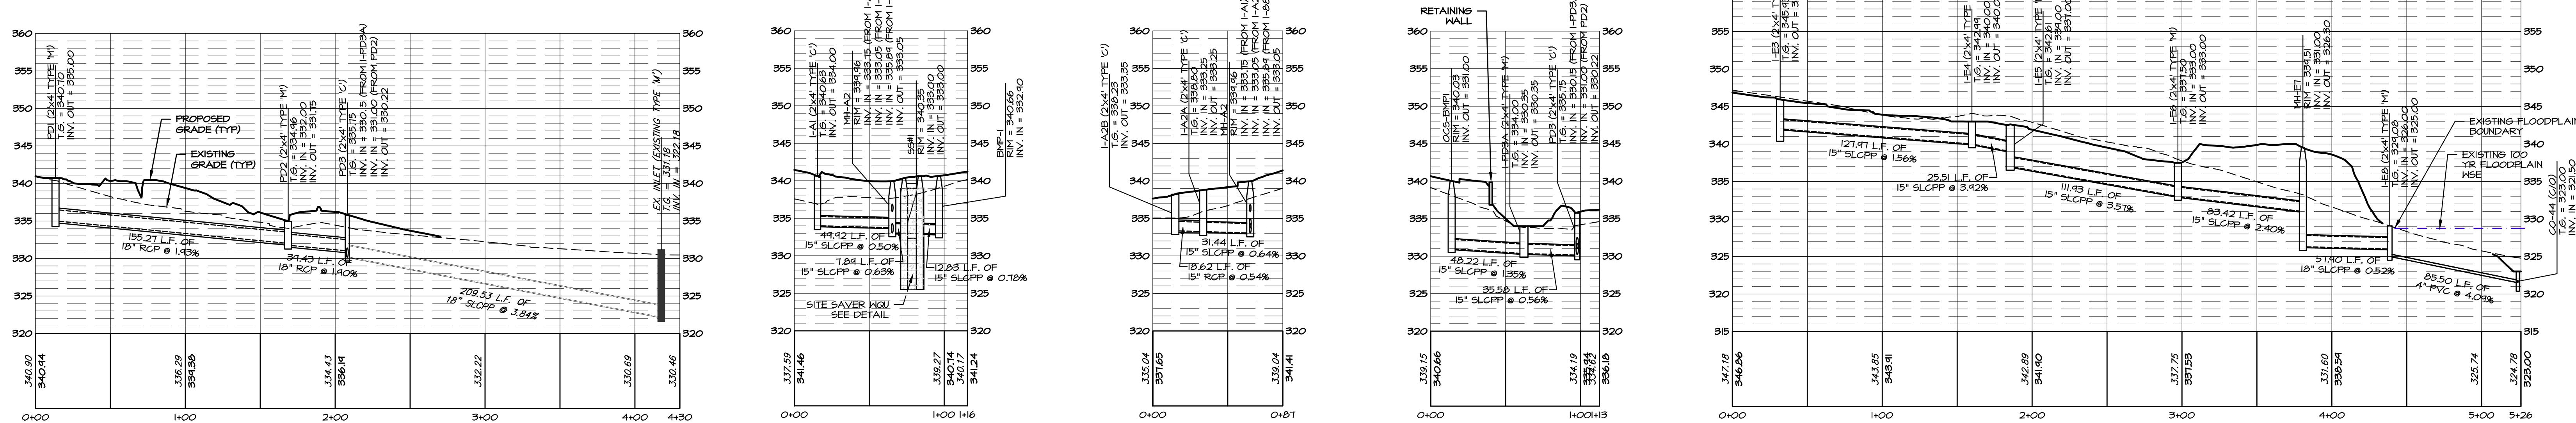


PD-1 TO EX. INLET  
HORZ. SCALE: 1"=50'  
VERT. SCALE: 1"= 10'

I-A1 TO BMP-1  
HORZ. SCALE: 1"=50'  
VERT. SCALE: 1"= 10'

I-A2B TO MH-A2  
HORZ. SCALE: 1"=50'  
VERT. SCALE: 1"= 10'

BMP-1 TO PD-3  
HORZ. SCALE: 1"=50'  
VERT. SCALE: 1"= 10'

I-E3 TO CO-44  
HORZ. SCALE: 1"=50'  
VERT. SCALE: 1"= 10'

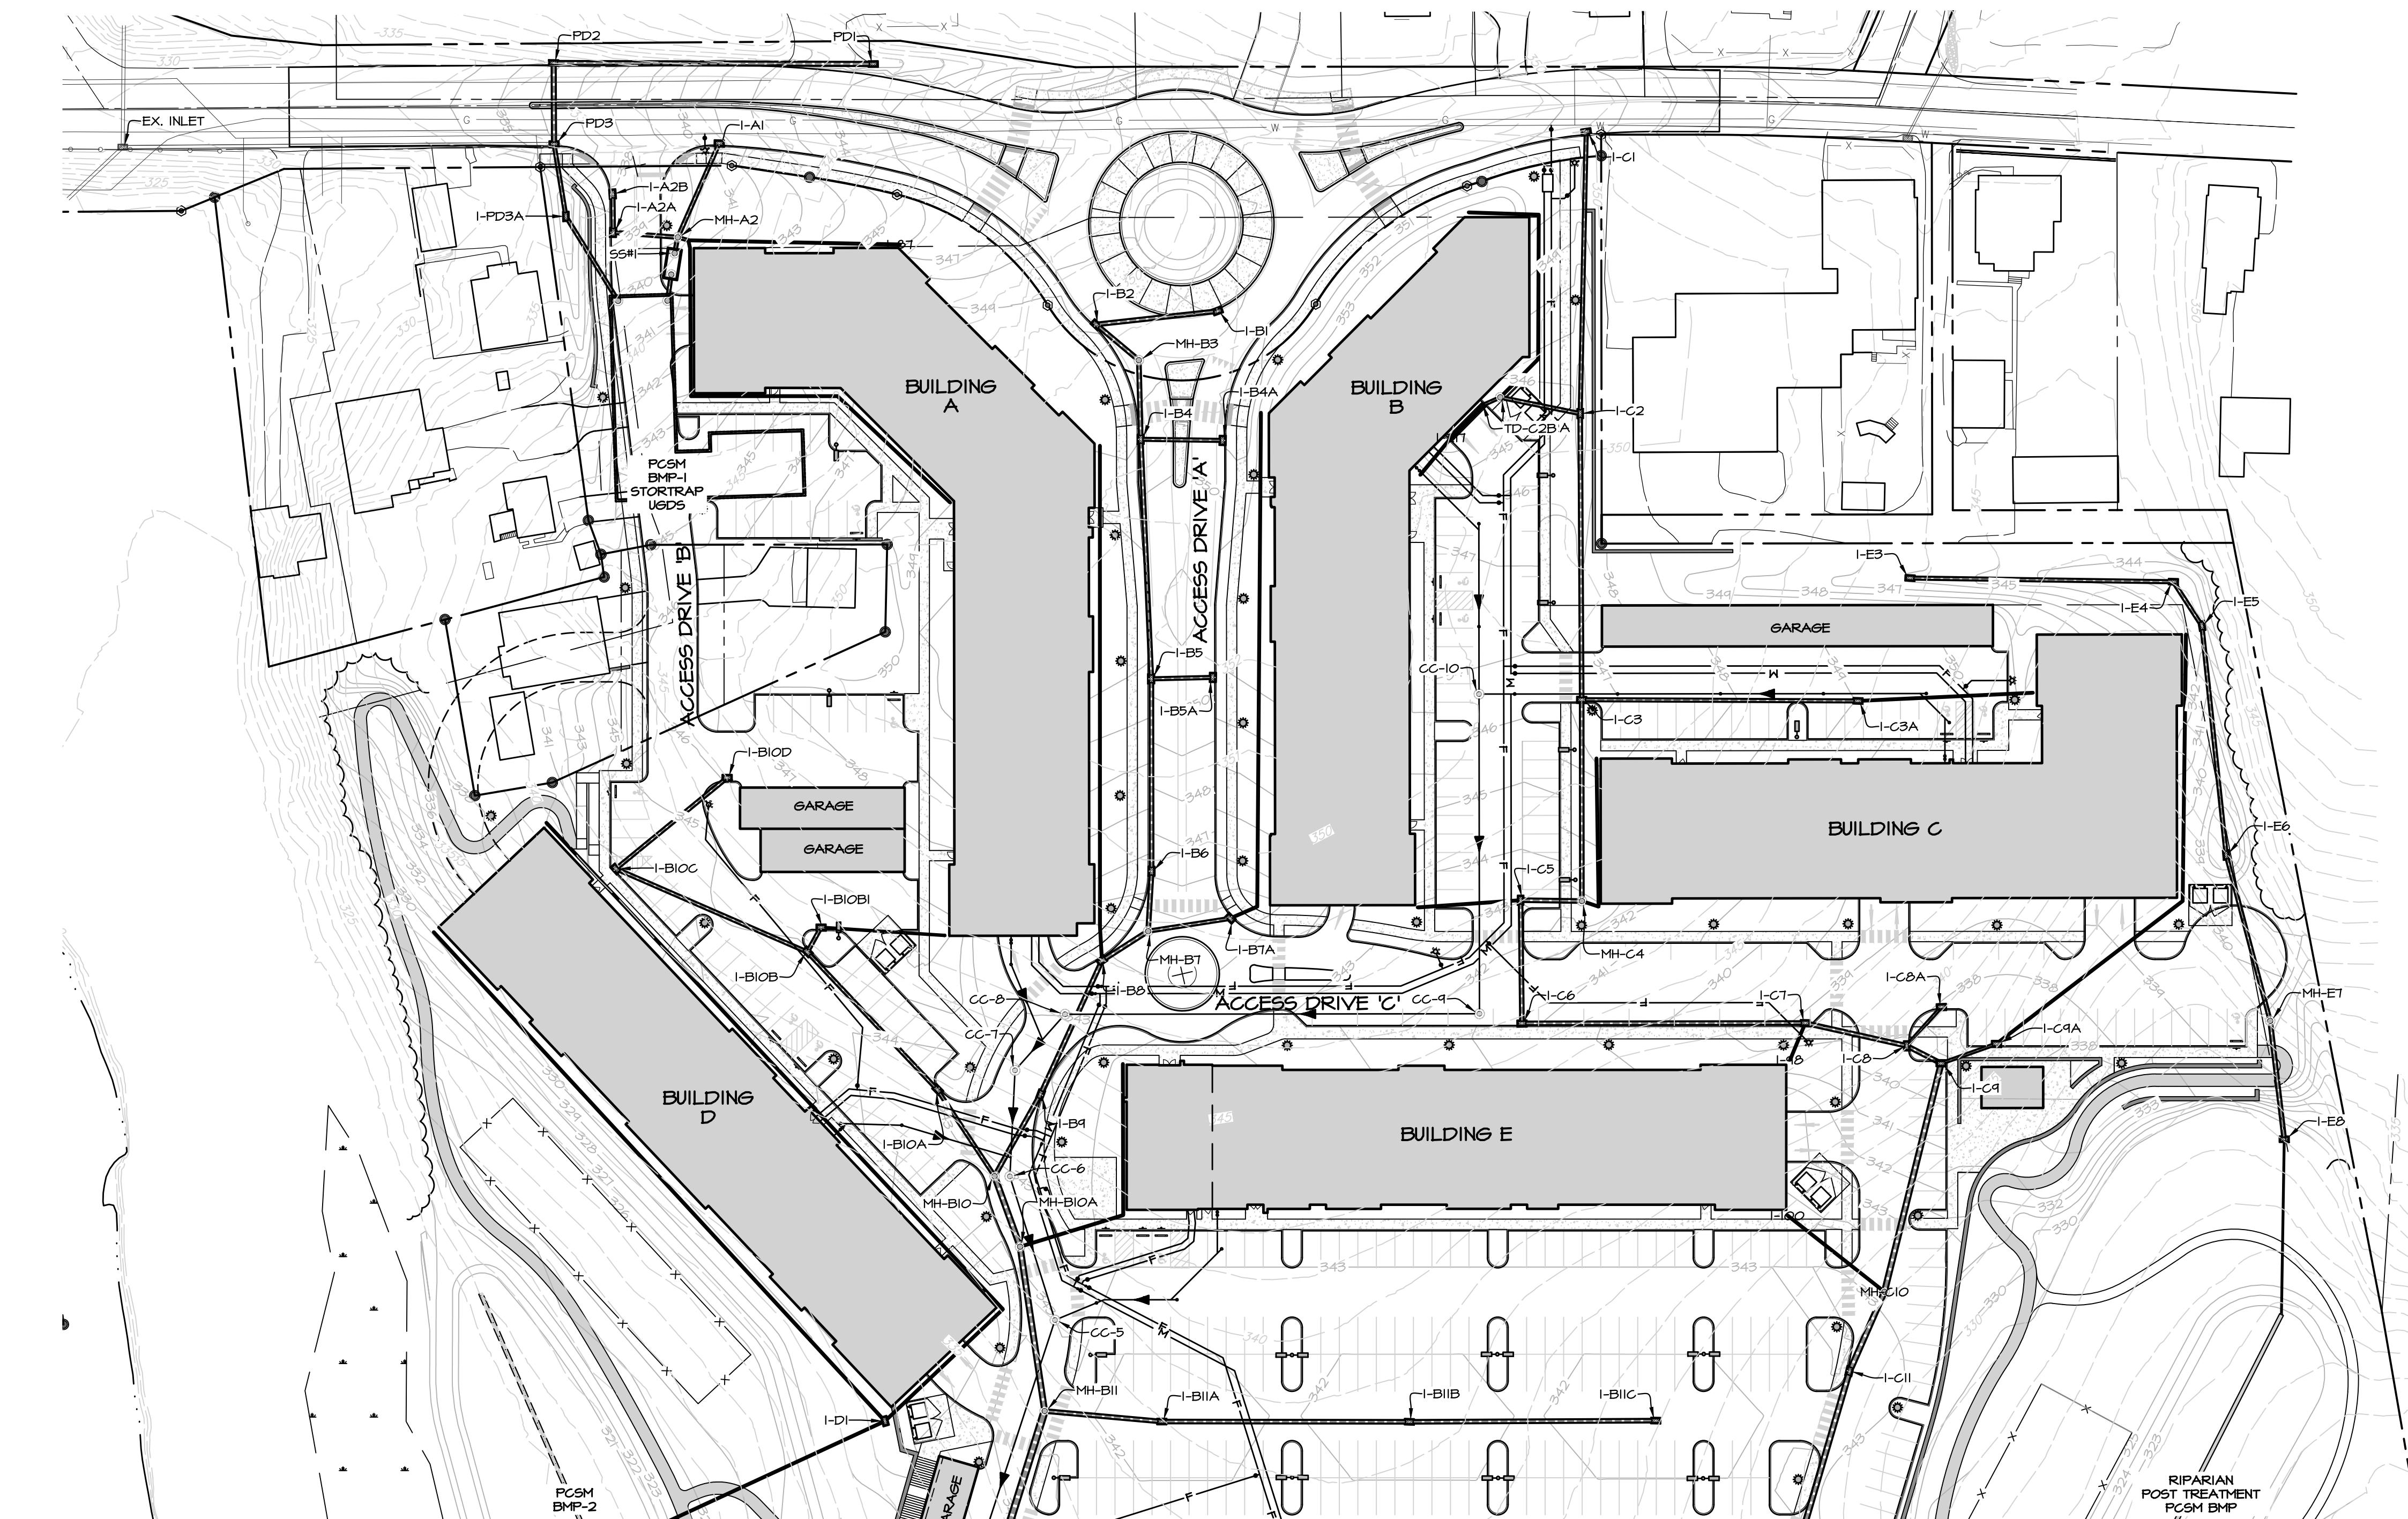

PLAN:

HORIZONTAL SCALE: 1" = 50'

#### NOTES


- CONTRACTOR SHALL FIELD VERIFY LOCATION OF ALL EXISTING UTILITIES PRIOR TO COMMENCEMENT OF EXCAVATION. ADJUST UTILITIES AS REQUIRED TO ALLOW INSTALLATION OF STORMWATER CONVEYANCE SYSTEM. COORDINATE ALL WORK WITH UTILITY PROVIDERS AND THE OWNER.
- INLETS SHALL INCLUDE A 2-INCH T.G. SUMP WHERE INDICATED IN THE PROFILES (IF APPLICABLE). PLEASE NOTE THE T.G. ELEVATION VALUES LABELED IN THE PROFILES ALREADY REFLECT THE 2" DEPRESSION AND OUT. OUT SHOULD NOT BE SUBTRACTED FROM THE T.G. VALUE.
- ALL SMOOTH LINED CORRUGATED POLYETHYLENE STORM PIPE (SLCPP) SHALL BE PROVIDED WITH INTEGRAL BELL AND SPIGOT JOINT MEETING THE REQUIREMENTS OF AASHTO M252, AASHTO M244, OR ASTM F2306. THE PIPE SHALL BE HAULAGED ACCORDING TO THE REQUIREMENTS OF ASTM D292. GASKETS SHALL MEET THE REQUIREMENTS OF THE FACTORY AND SHALL BE INSTALLED BY THE PIPE MANUFACTURER AND COVERED WITH A REMOVABLE, PROTECTIVE WRAP TO ENSURE THE GASKET IS FREE OF DEBRIS. ALL REINFORCED CONCRETE STORM PIPE (RCP) SHALL BE PROVIDED WITH WATERTIGHT "O" RING GASKETS.
- CONTRACTOR SHALL PROVIDE MINIMUM VERTICAL SEPARATION OF 18" BETWEEN EXISTING OR PROPOSED WATER/GAS LINES AND STORM PIPES / INLETS.
- PIPE INTERFACE WITH WALL SHALL BE INCORPORATED BY WALL DESIGN (BY OTHERS) AND COORDINATED BY CONTRACTOR DURING CONSTRUCTION.

SCALE IN FEET: 1" = 50'  
0 25 50 100 150

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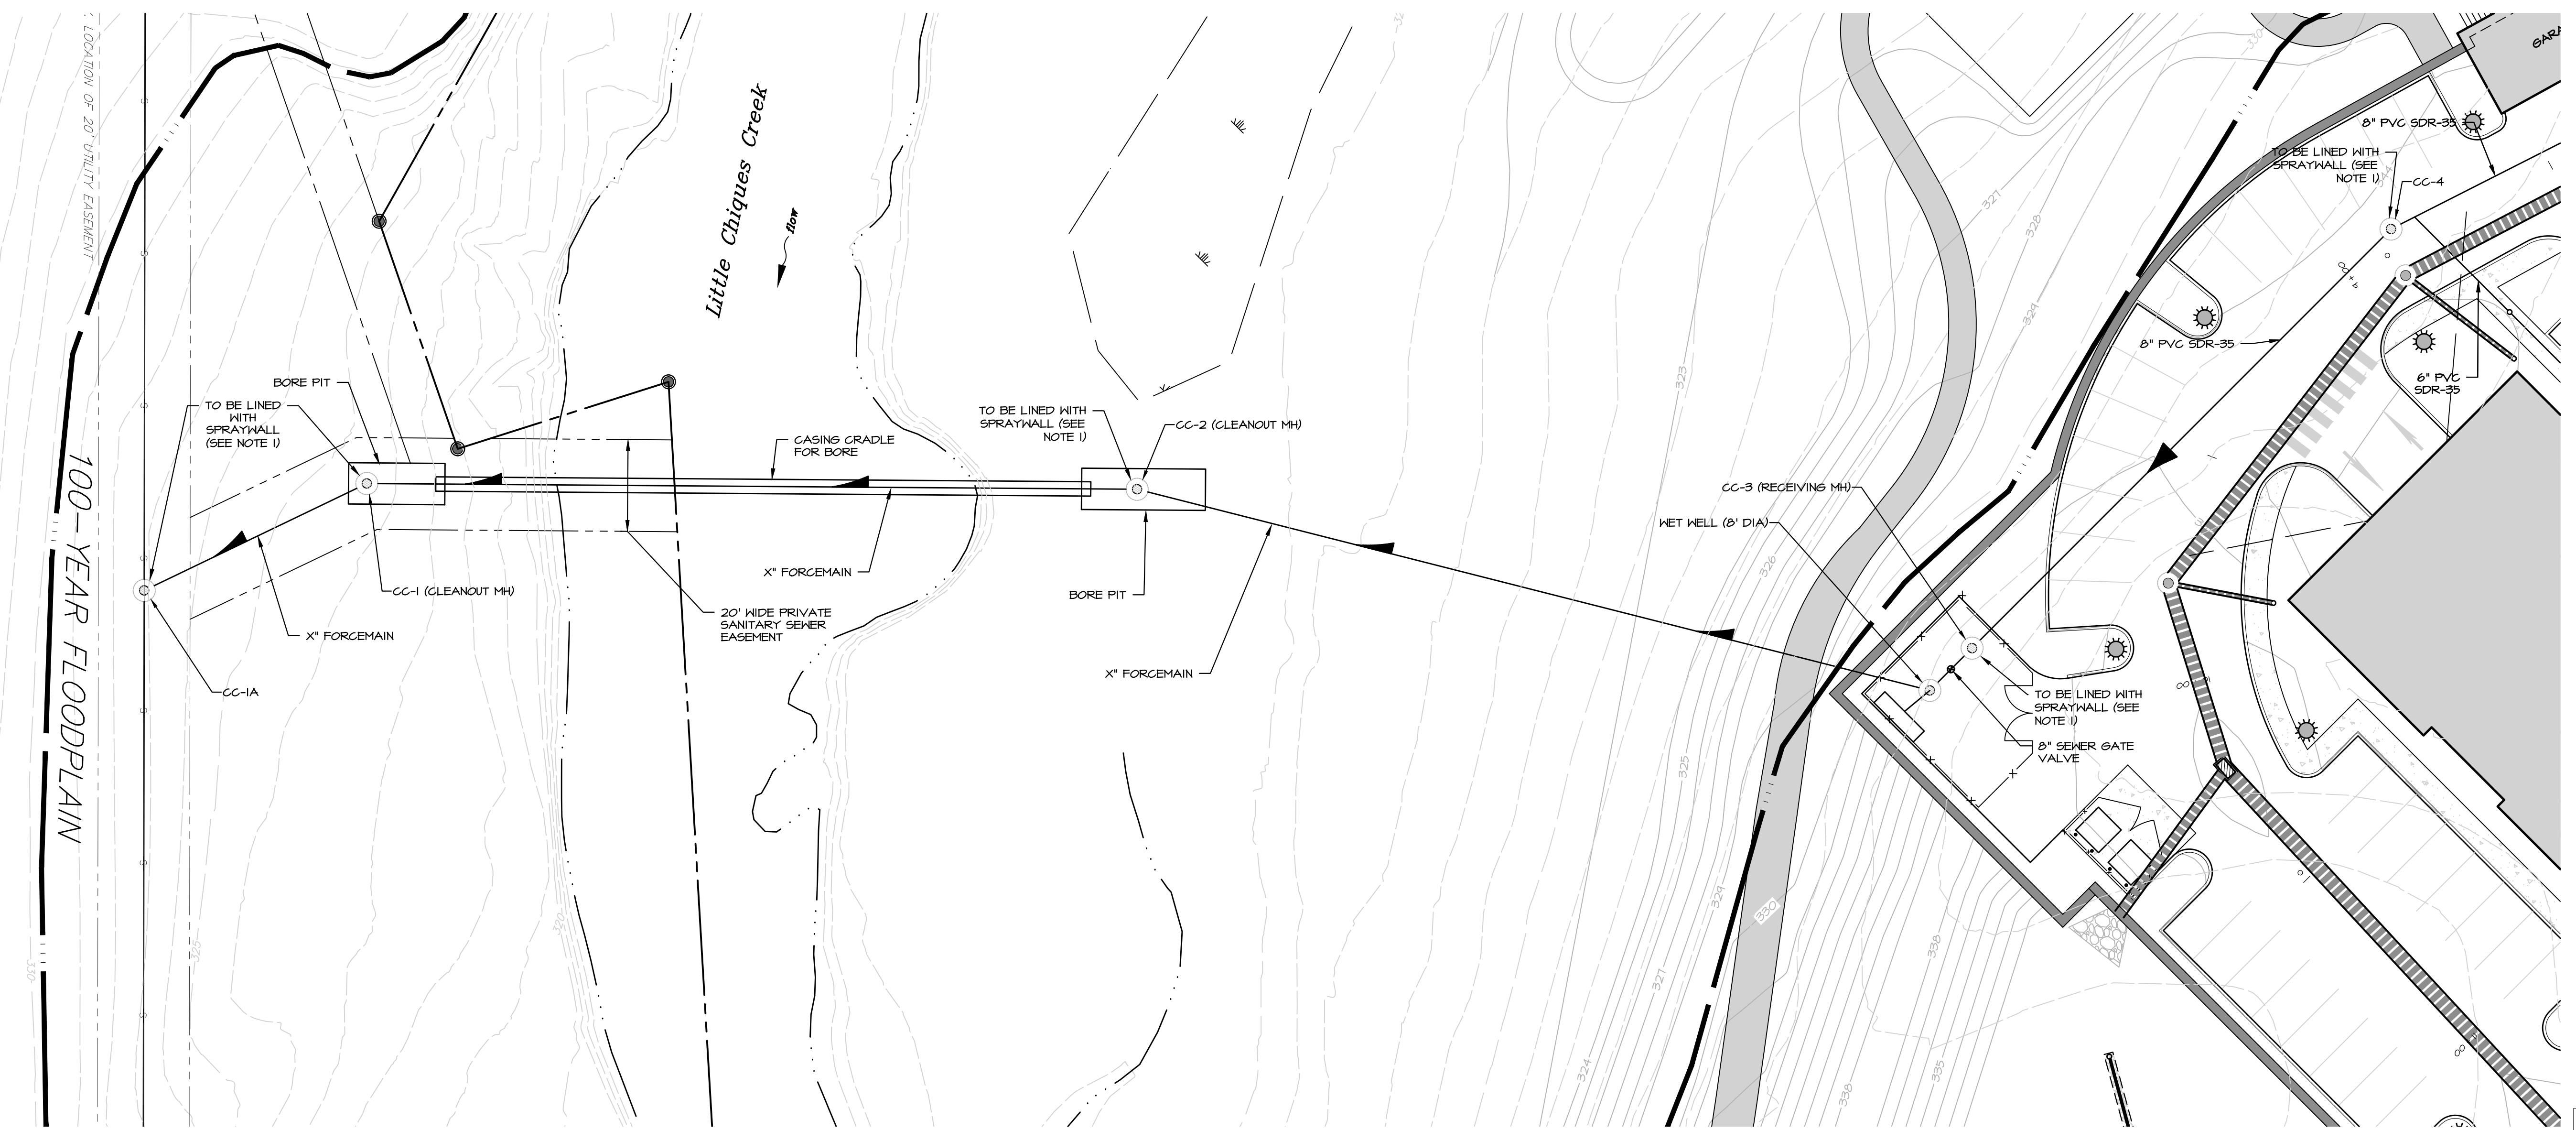


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CONDITIONAL USE PLAN  
SUBJECT:  
STORMWATER PLAN & PROFILES  
FOR  
CHIQUES CROSSING  
RAPHO TOWNSHIP, LANCASTER COUNTY, PENNSYLVANIA  
CLIENT:  
VISTABLOCK, LLC  
150 FARMINGTON LANE  
LANCASTER, PA 17601  
717-682-7775


MANAGER: BDG DATE: JAN 5, 2024  
DESIGNER: DJM PROJECT NO. 1212-002  
DRAWN BY: BLM SCALE: AS SHOWN

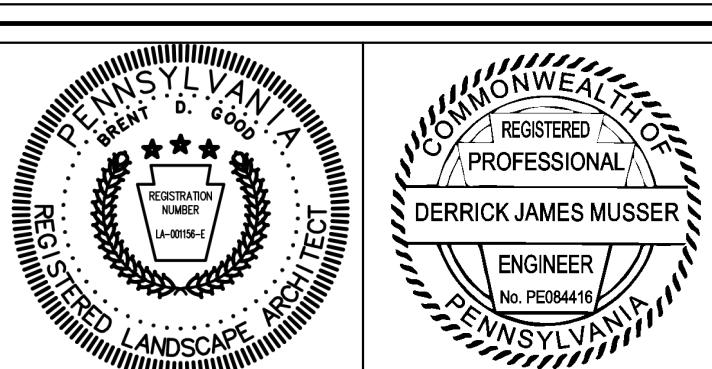

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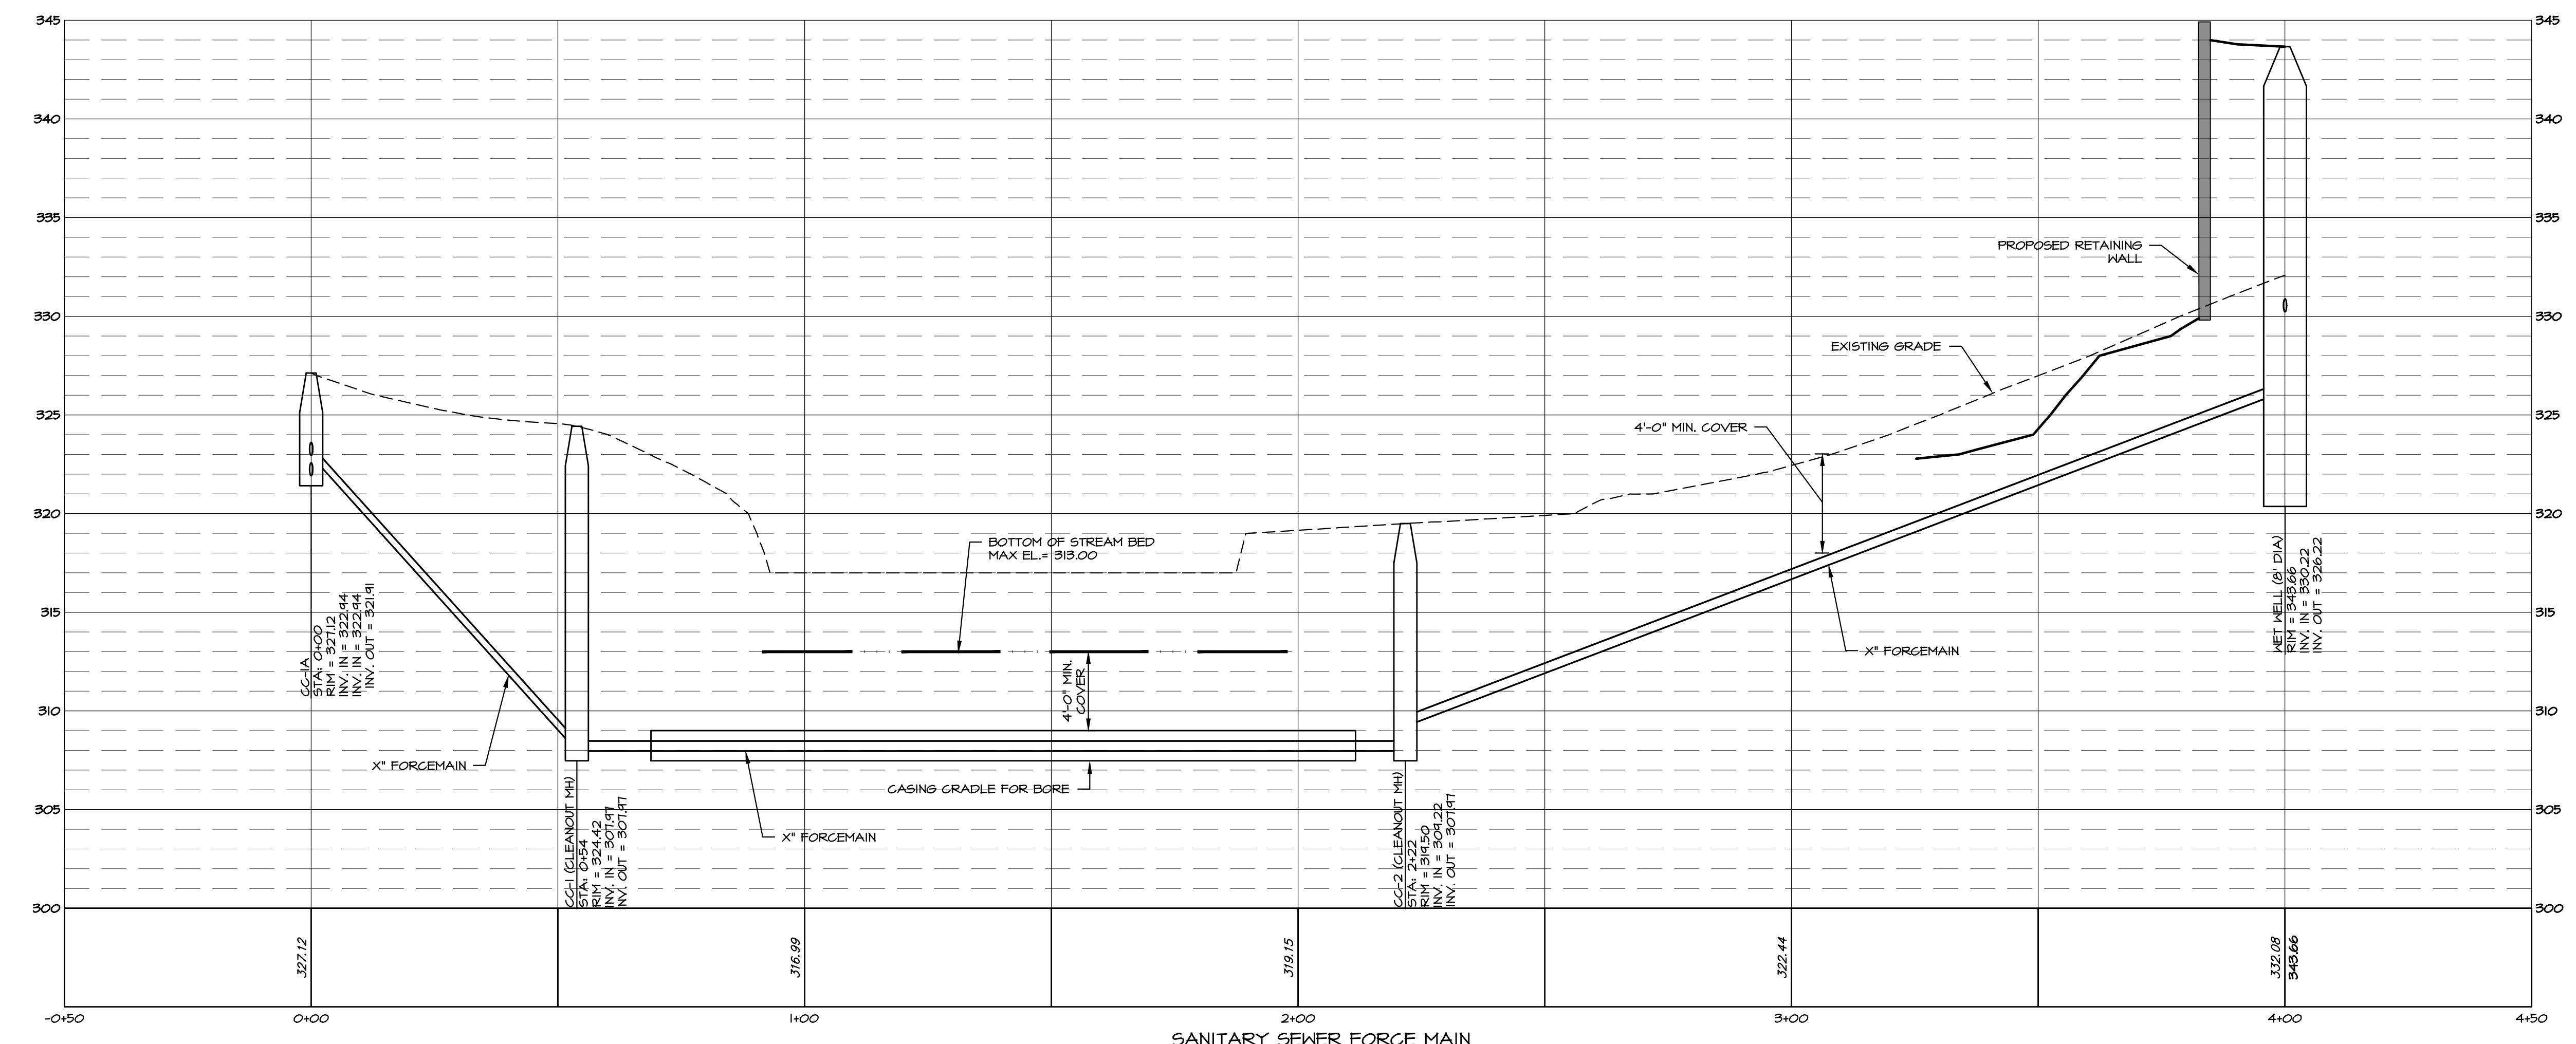
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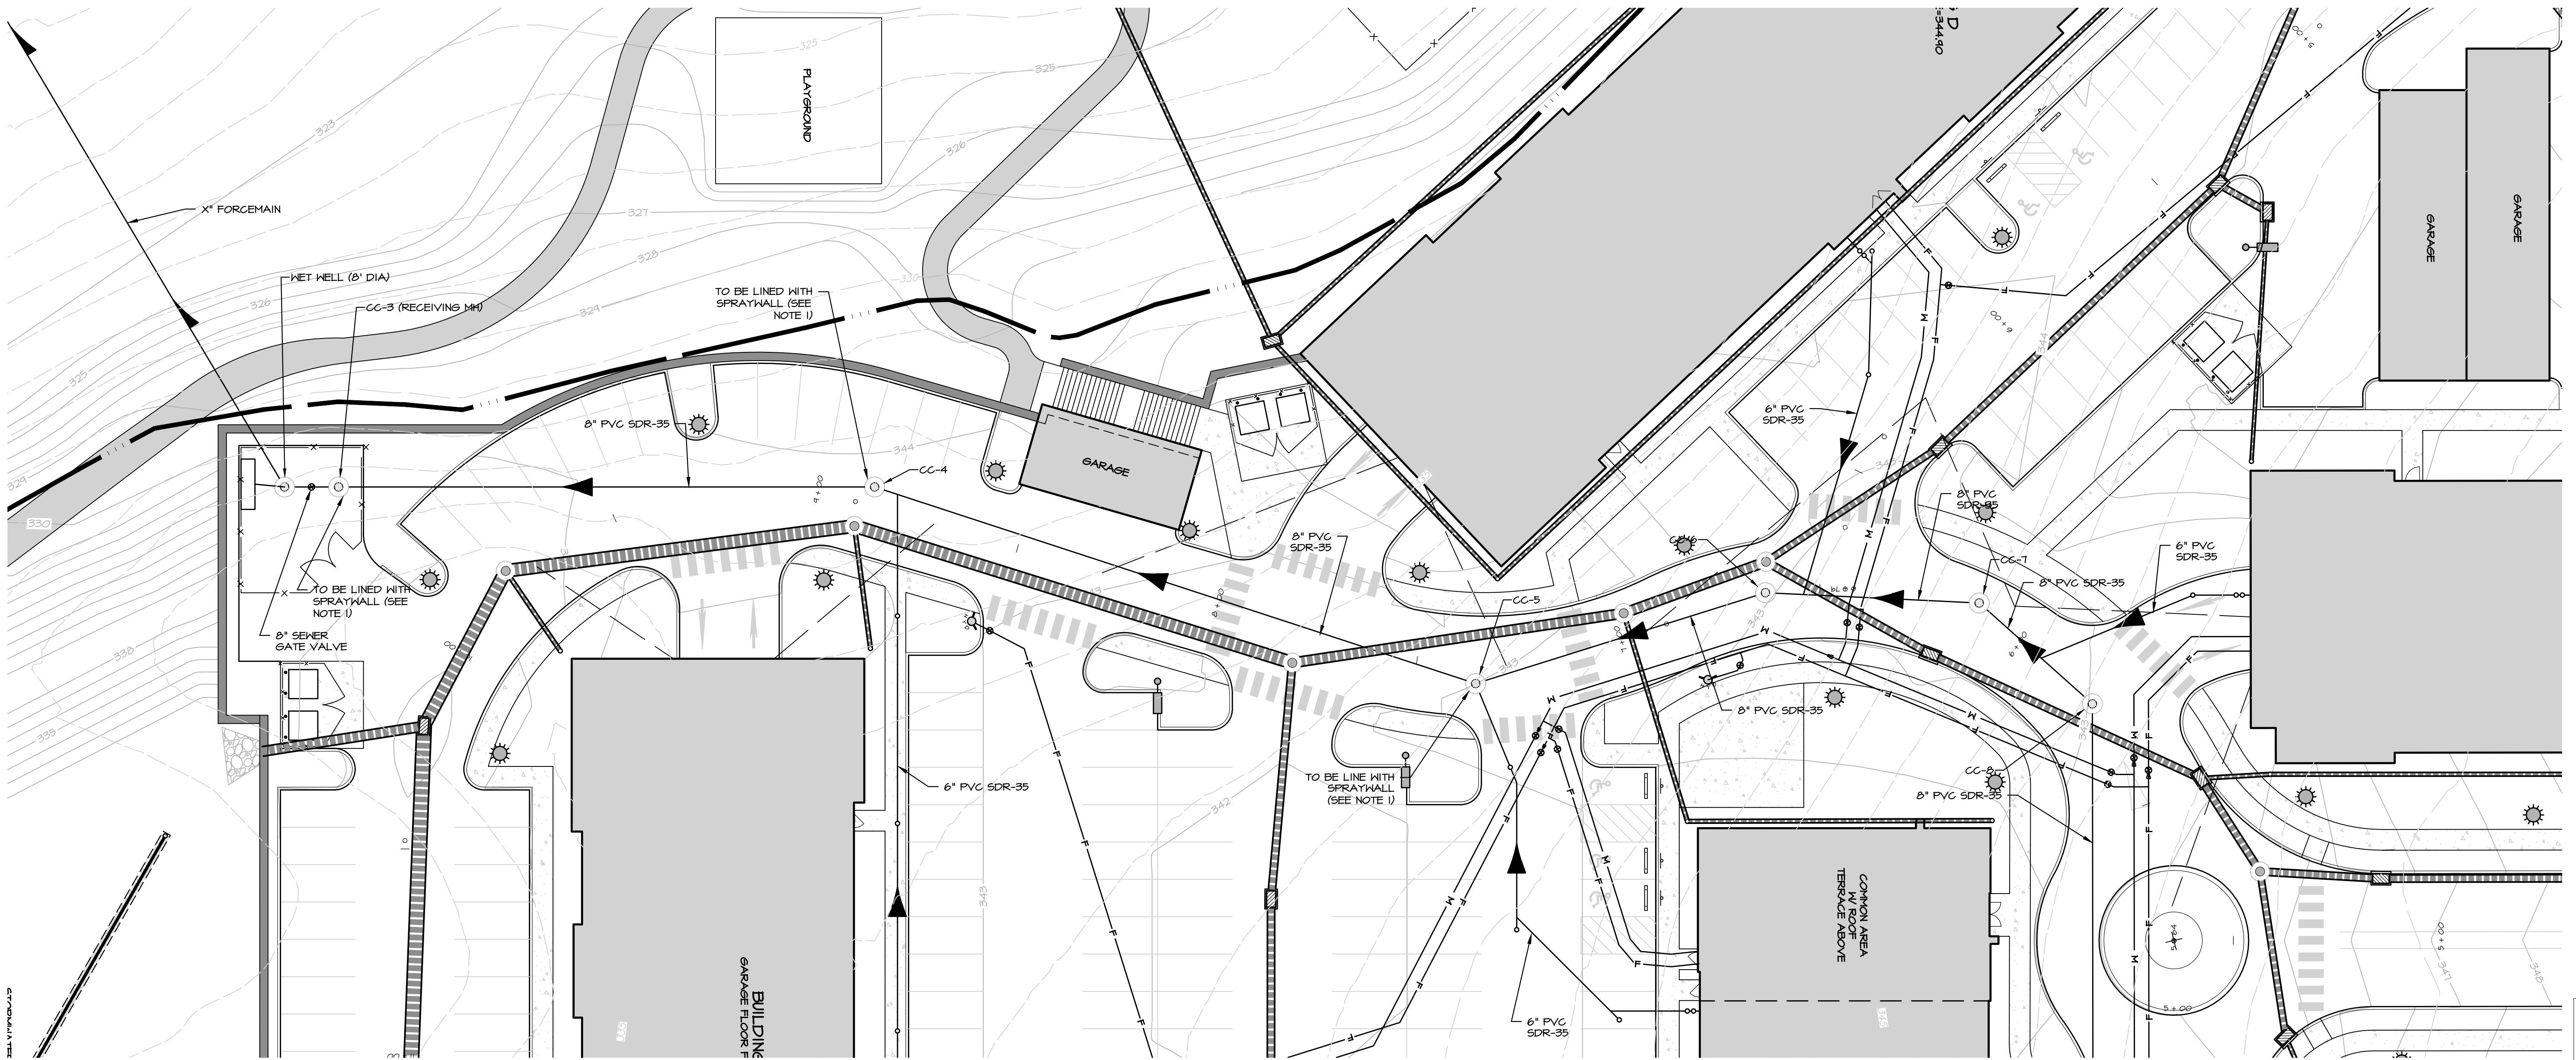


CONDITIONAL USE PLAN  
SUBJECT:  
UTILITY PLAN & PROFILES  
FOR  
CHIQUES CROSSING  
RAPHO TOWNSHIP, LANCASTER COUNTY, PENNSYLVANIA  
CLIENT:  
VISTABLOCK, LLC  
150 FARMINGTON LANE  
LANCASTER, PA 17601  
717-682-8775

MANAGER: BDG DATE: JAN 5, 2024  
DESIGNER: DJM PROJECT NO. 1212-002  
DRAWN BY: BLM SCALE: AS SHOWN

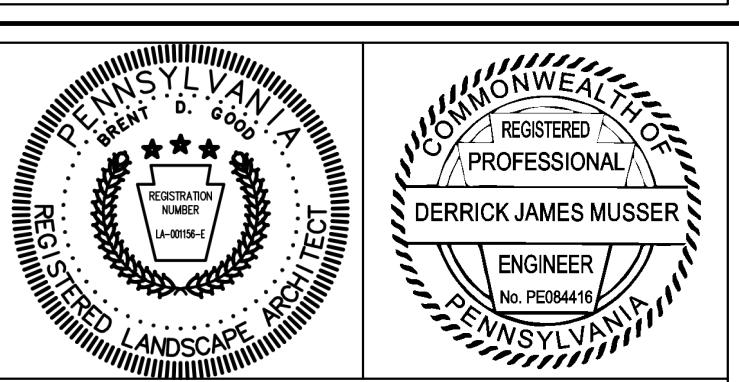DRAWING NO.  
**45 of 78**






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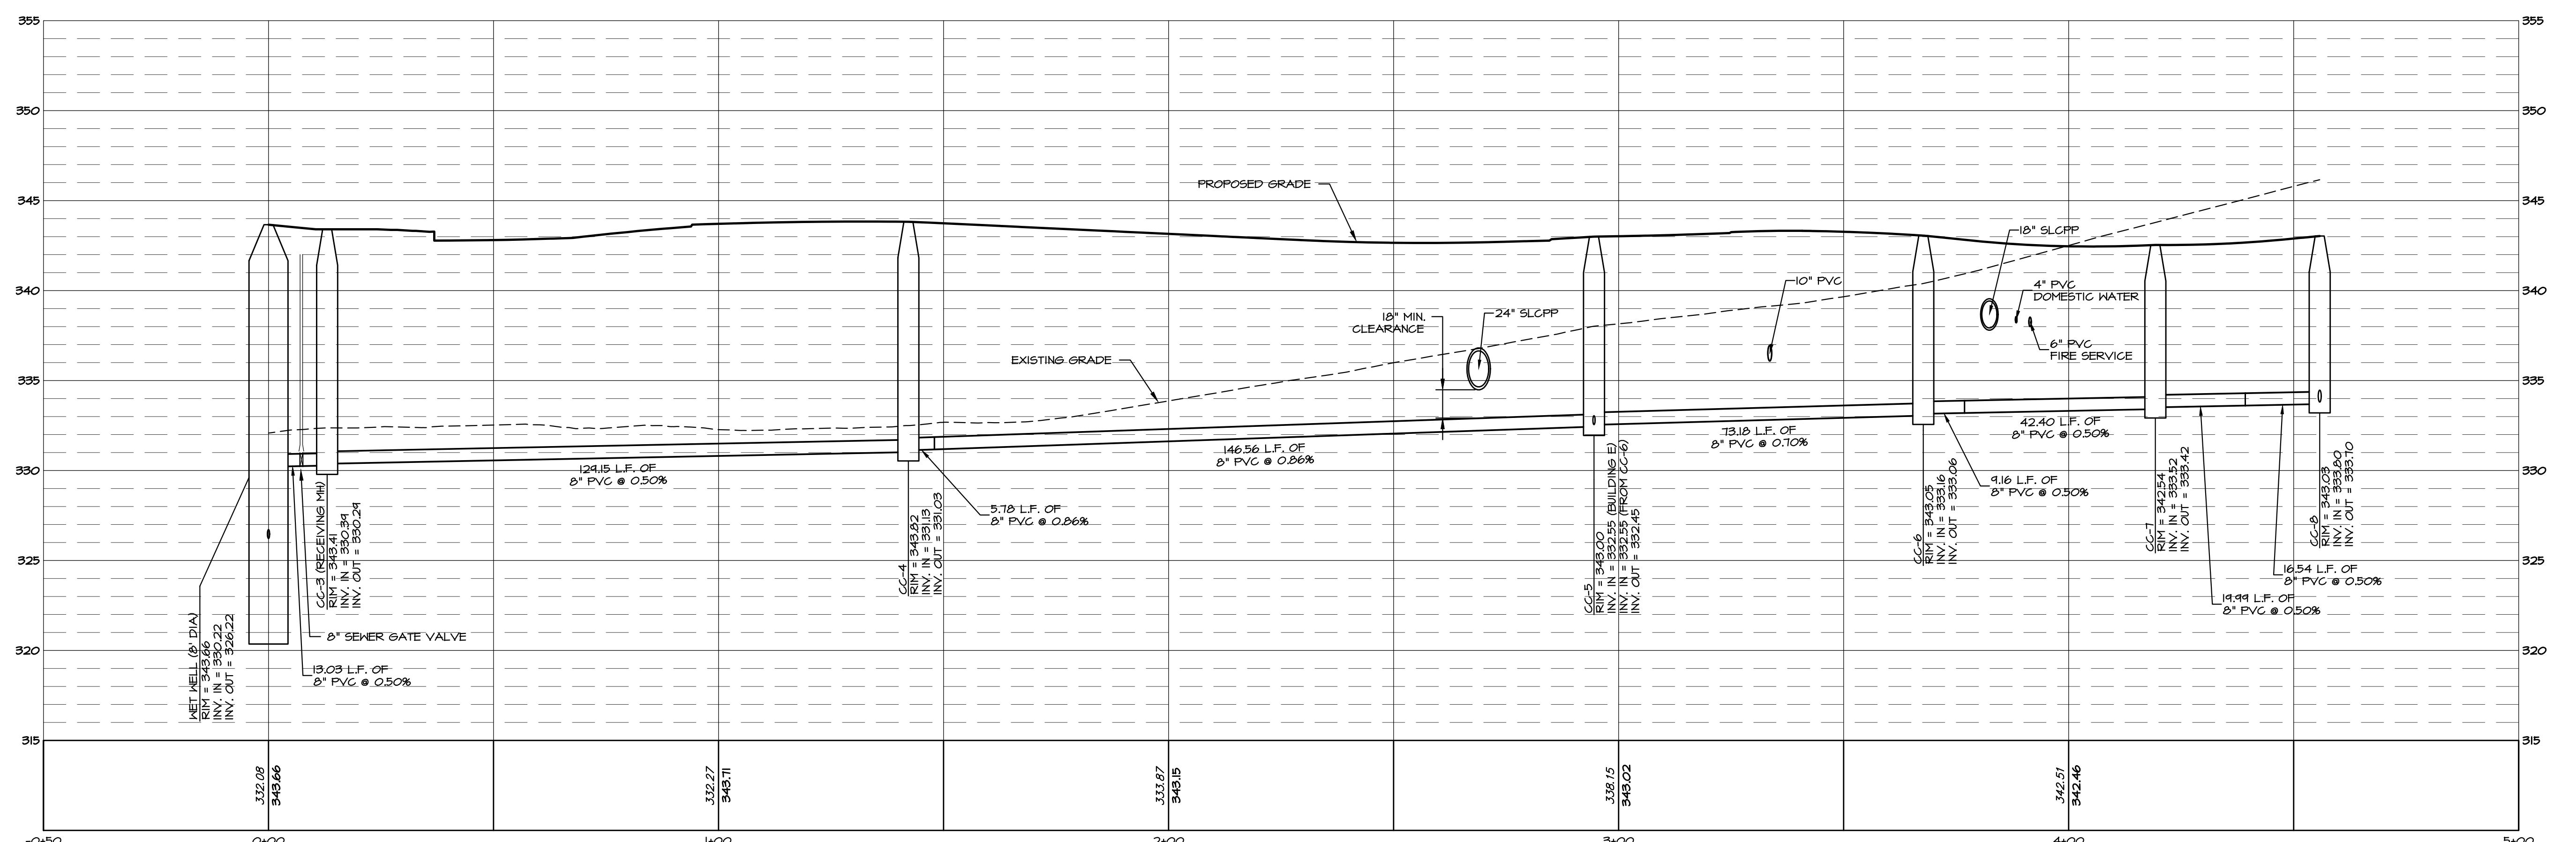
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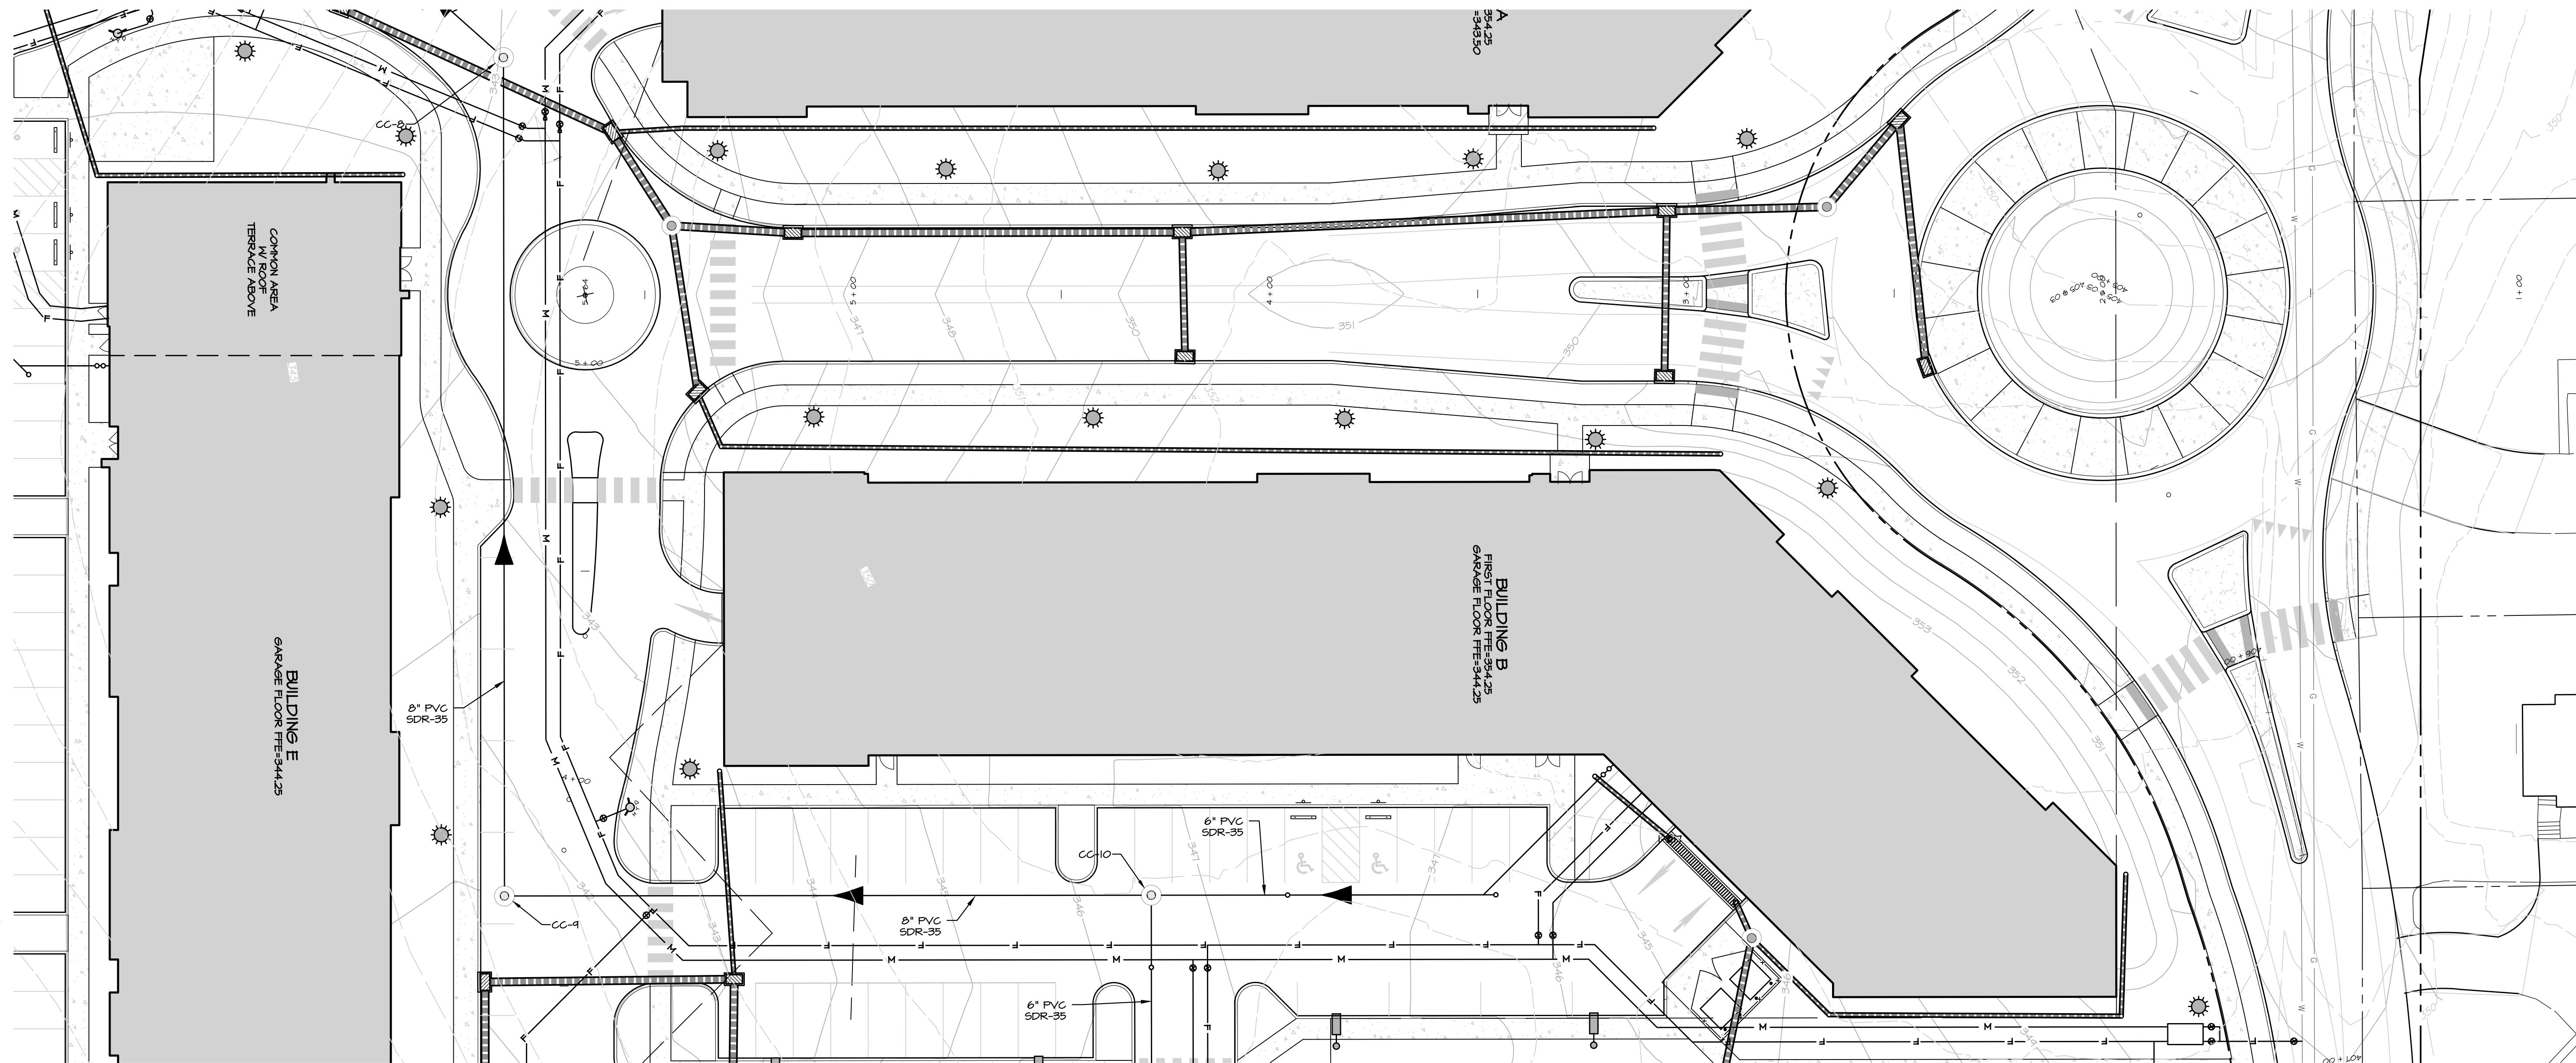


CONDITIONAL USE PLAN  
SUBJECT:  
UTILITY PLAN & PROFILES  
FOR  
CHIQUES CROSSING  
RAPHO TOWNSHIP, LANCASTER COUNTY, PENNSYLVANIA  
CLIENT:  
VISTABLOCK, LLC  
150 FARMINGTON LANE  
LANCASTER, PA 17601  
717-682-8775

MANAGER: BDG DATE: JAN 5, 2024  
DESIGNER: DJM PROJECT NO. 1212-002  
DRAWN BY: BLM SCALE: AS SHOWN

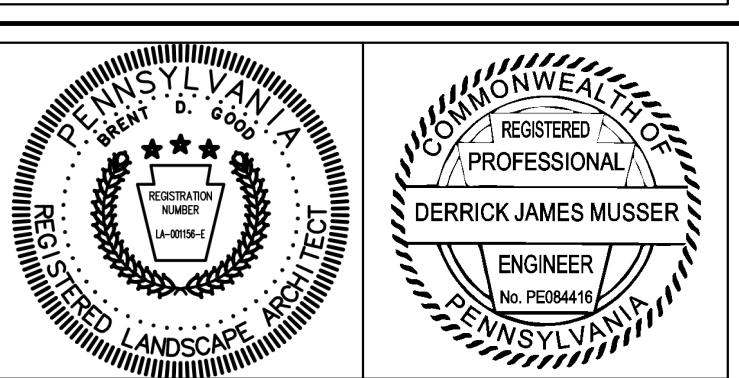DRAWING NO.  
**46 of 78**






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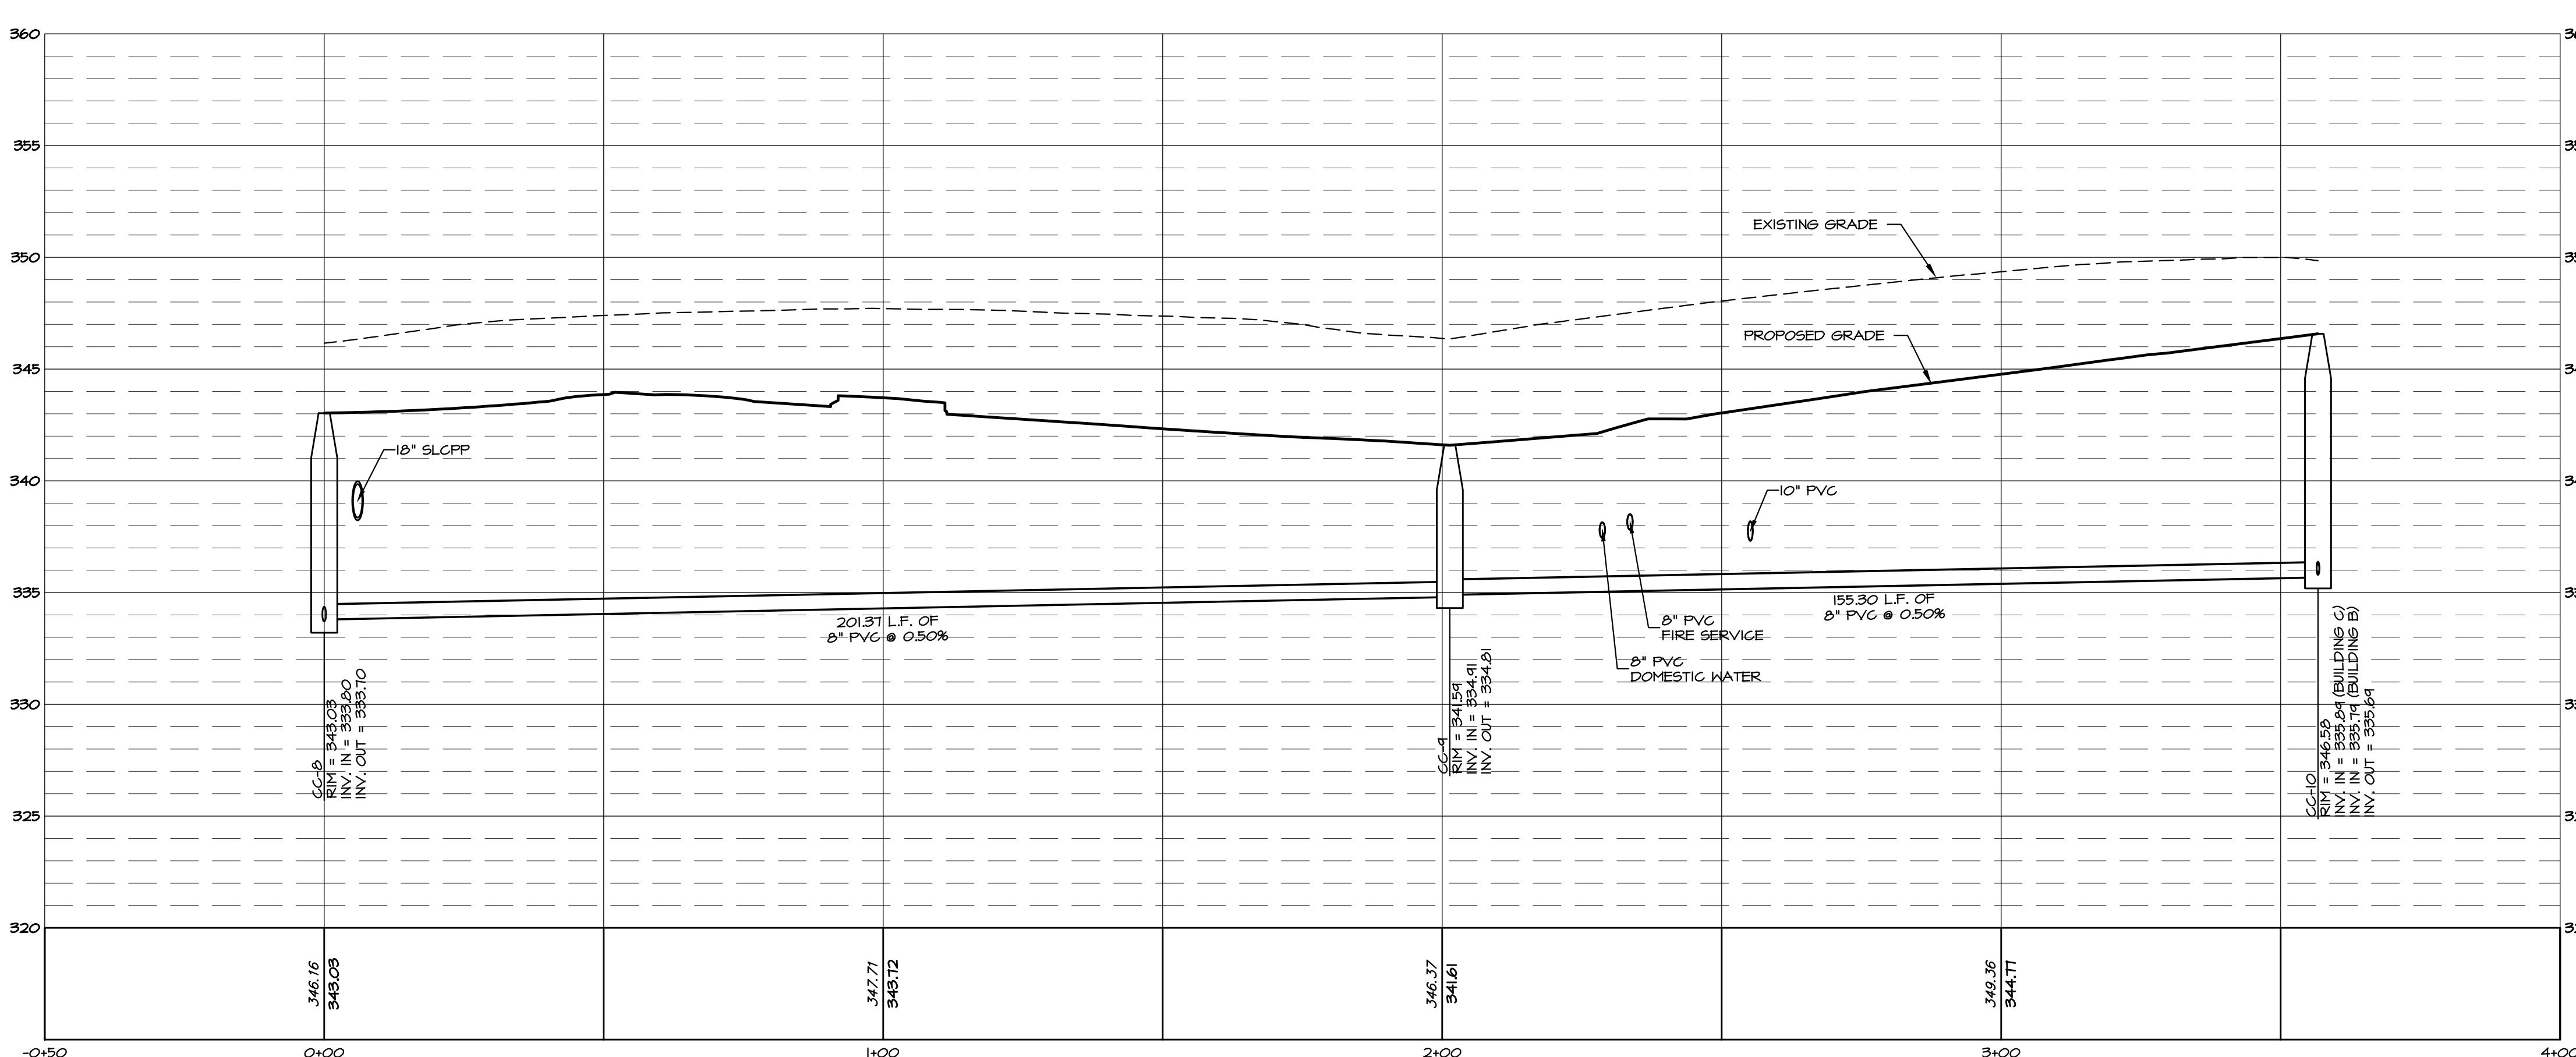
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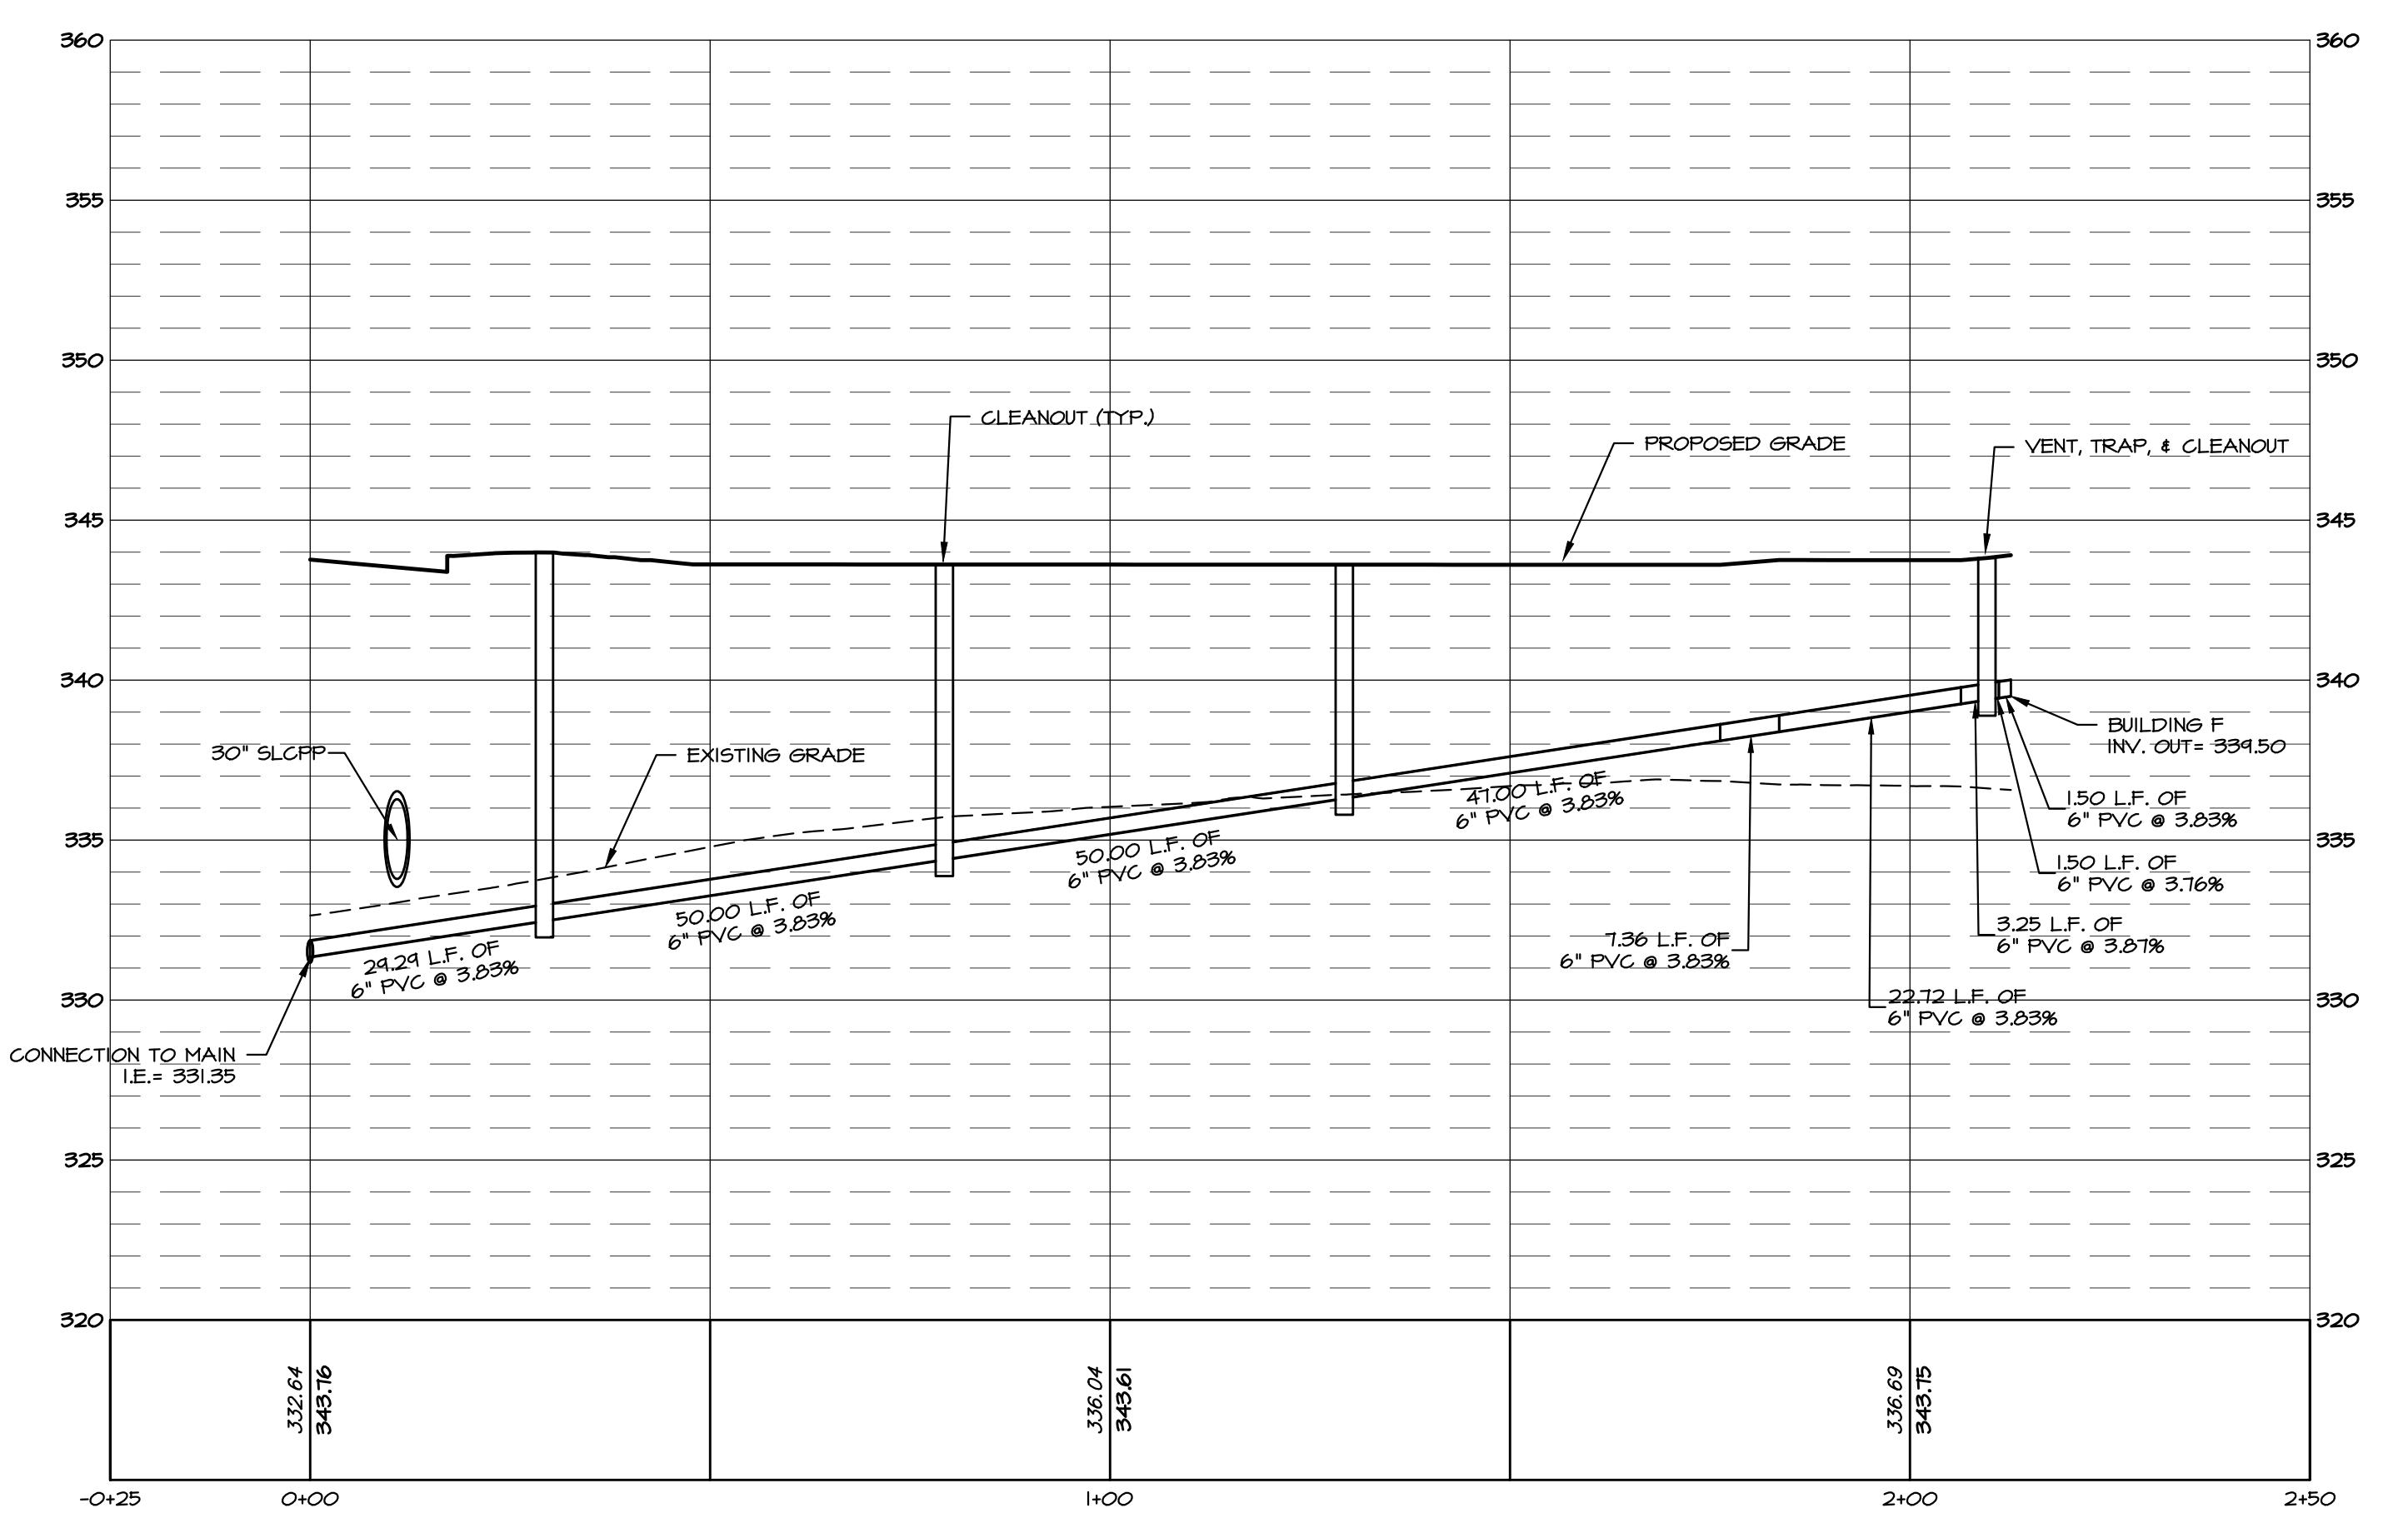
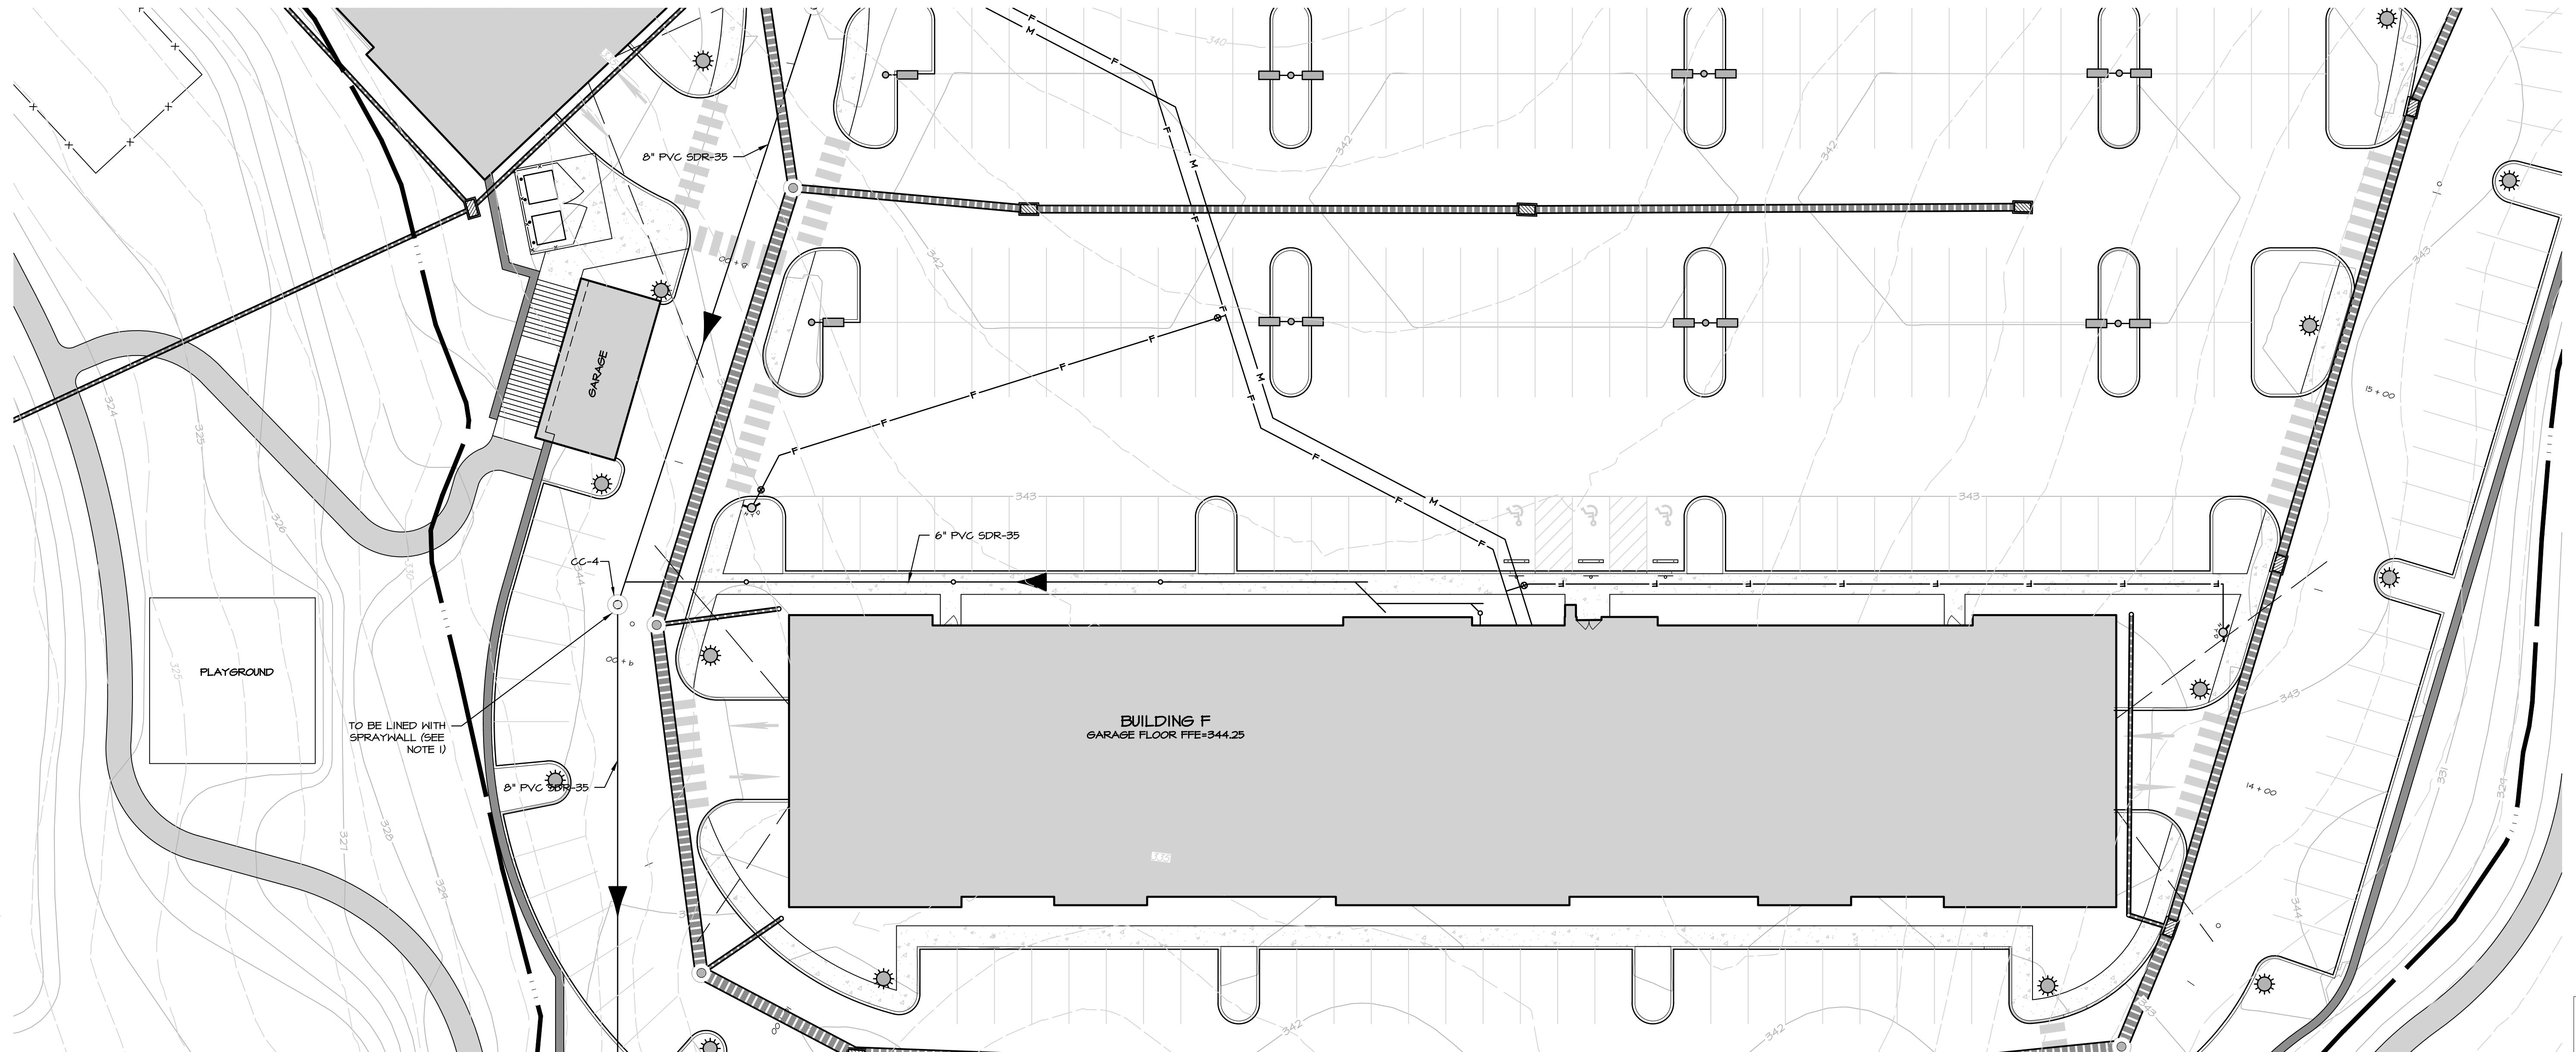
CONDITIONAL USE PLAN  
SUBJECT:  
UTILITY PLAN & PROFILES  
FOR  
CHIQUES CROSSING  
RAPHO TOWNSHIP, LANCASTER COUNTY, PENNSYLVANIA  
CLIENT:  
VISTABLOCK, LLC  
150 FARMINGTON LANE  
LANCASTER, PA 17601  
717-682-8775

MANAGER: BDG DATE: JAN 5, 2024  
DESIGNER: DJM PROJECT NO. 1212-002  
DRAWN BY: BLM SCALE: AS SHOWN

DRAWING NO.  
**47 of 78**

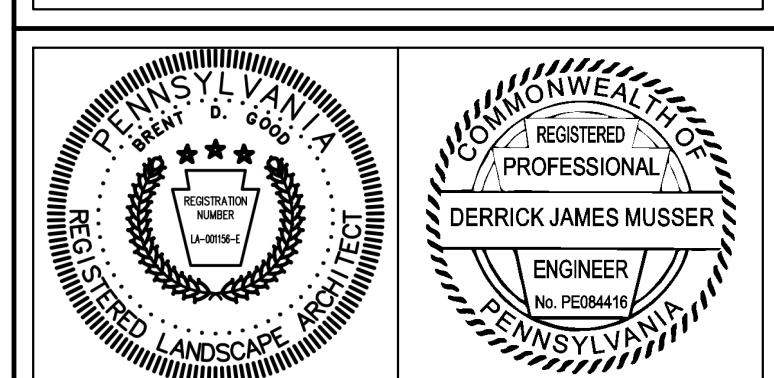

SITE GRAVITY SANITARY SEWER-CC-8 TO CC-10  
HORIZ. SCALE: 1"=20'  
VERT. SCALE: 1"-5"




BUILDING F SEWER LATERAL

I. MANHOLES CC-1A, CC-2, CC-3, CC-4, AND CC-5 SHALL BE LINED WITH SPRAYWALL BY SPRAYTEC, INC. IN ACCORDANCE WITH THE MANUFACTURER'S REQUIREMENTS.

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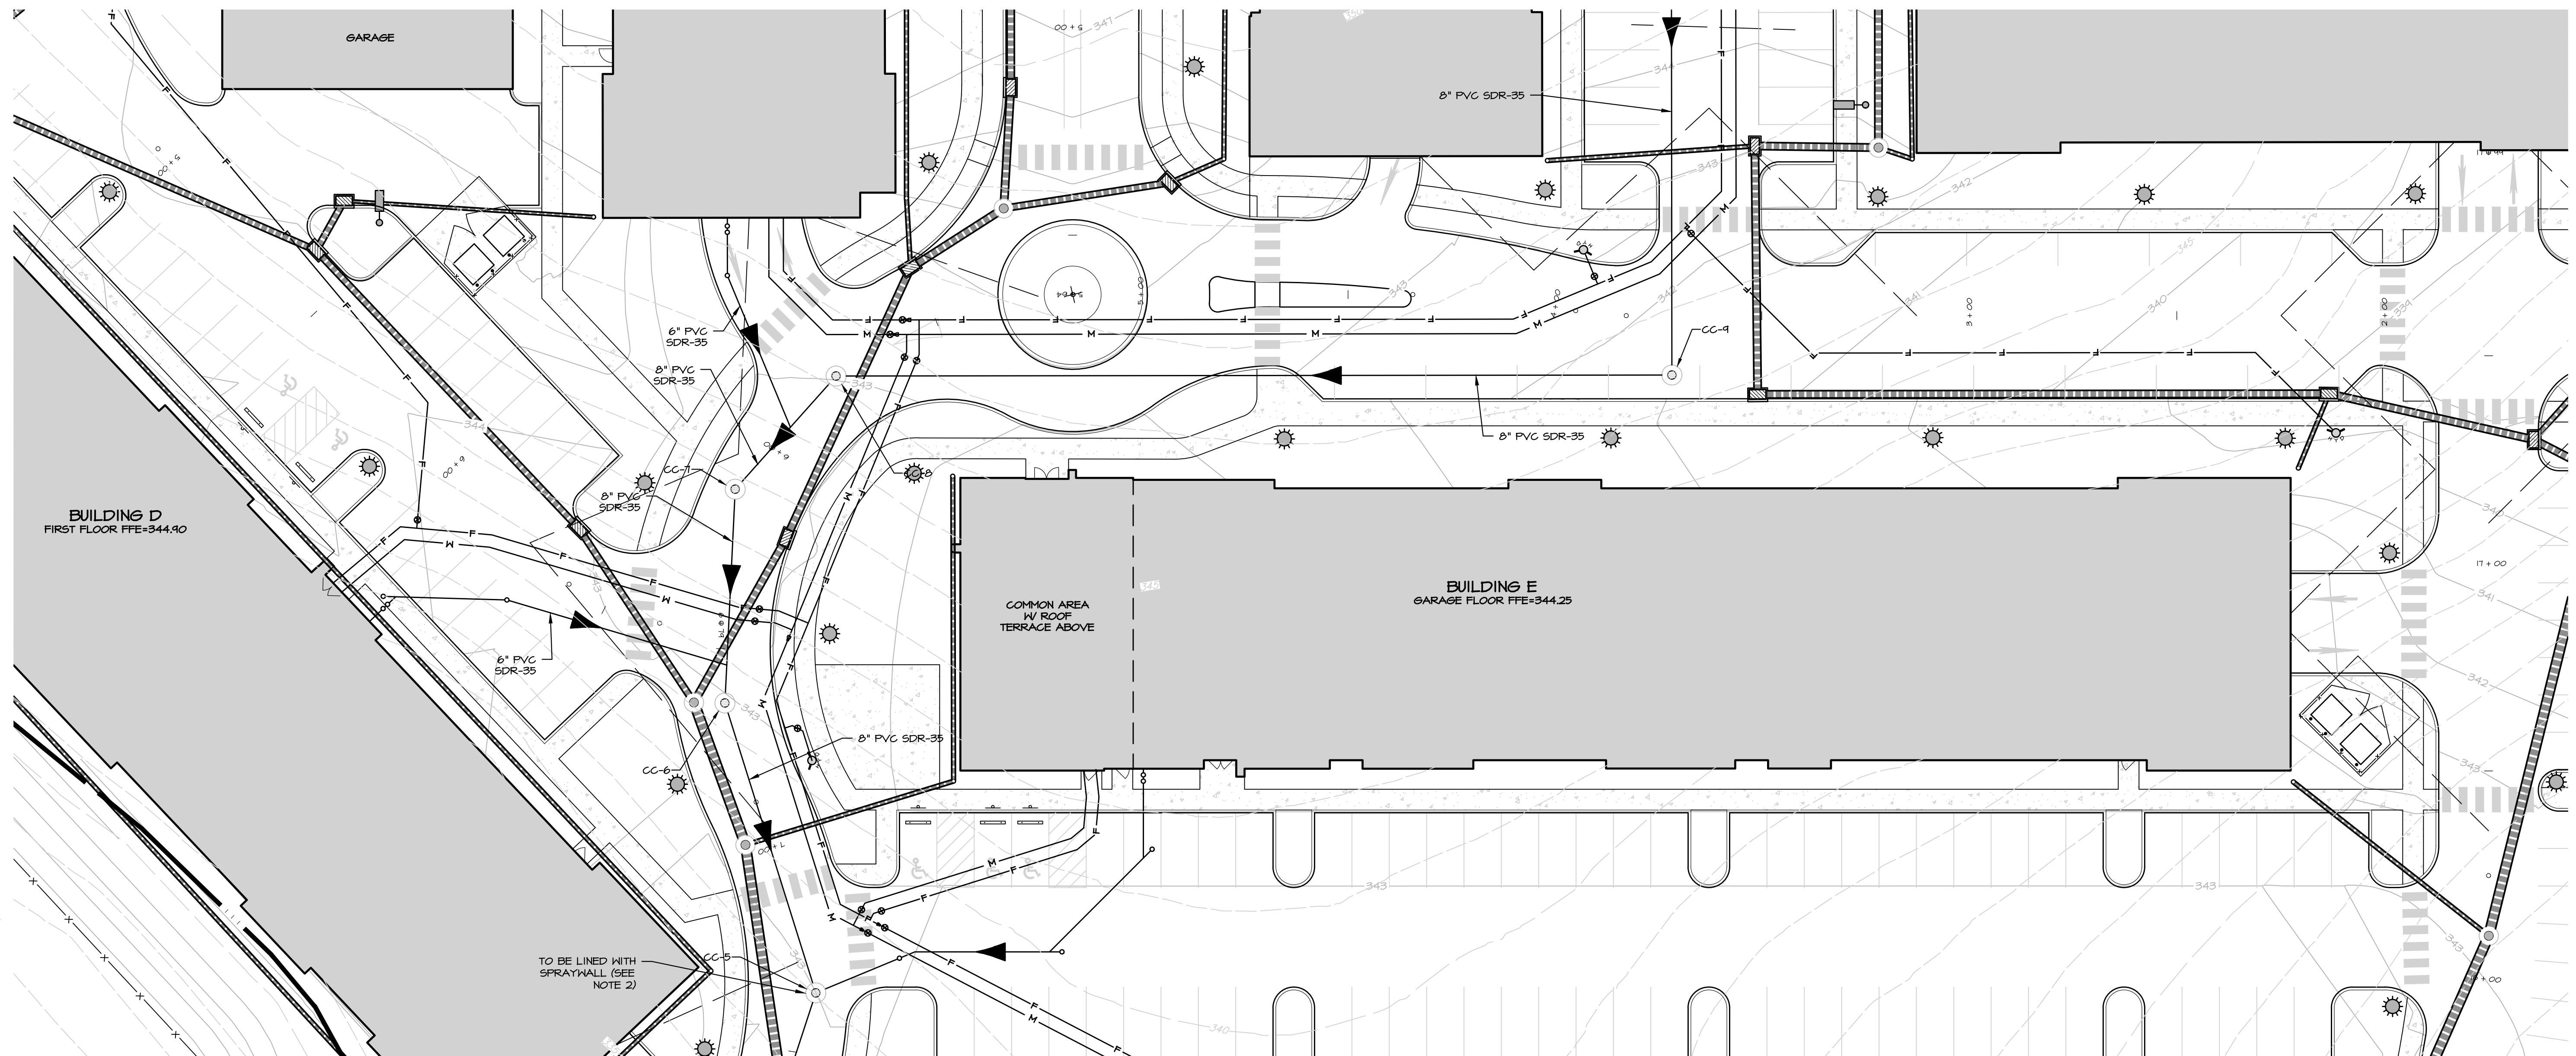


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CONDITIONAL USE PLAN  
SUBJECT:  
UTILITY PLAN & PROFILES  
FOR  
CHIQUES CROSSING  
RAPHO TOWNSHIP, LANCASTER COUNTY, PENNSYLVANIA  
CLIENT:  
VISTABLOCK, LLC  
150 FARMINGTON LANE  
LANCASTER, PA 17601  
717-682-8775


MANAGER: BDG DATE: JAN 5, 2024  
DESIGNER: DJM PROJECT NO. 1212-002  
DRAWN BY: BLM SCALE: AS SHOWN

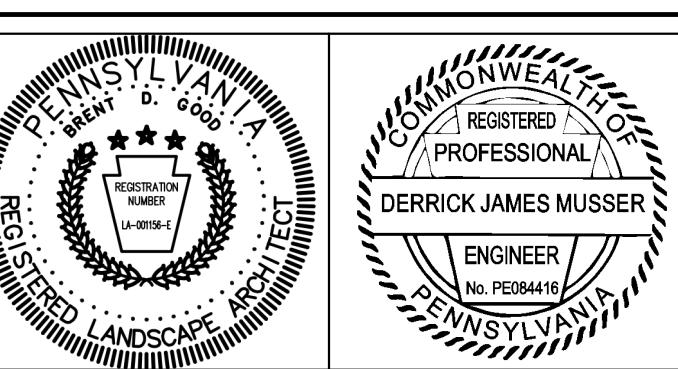

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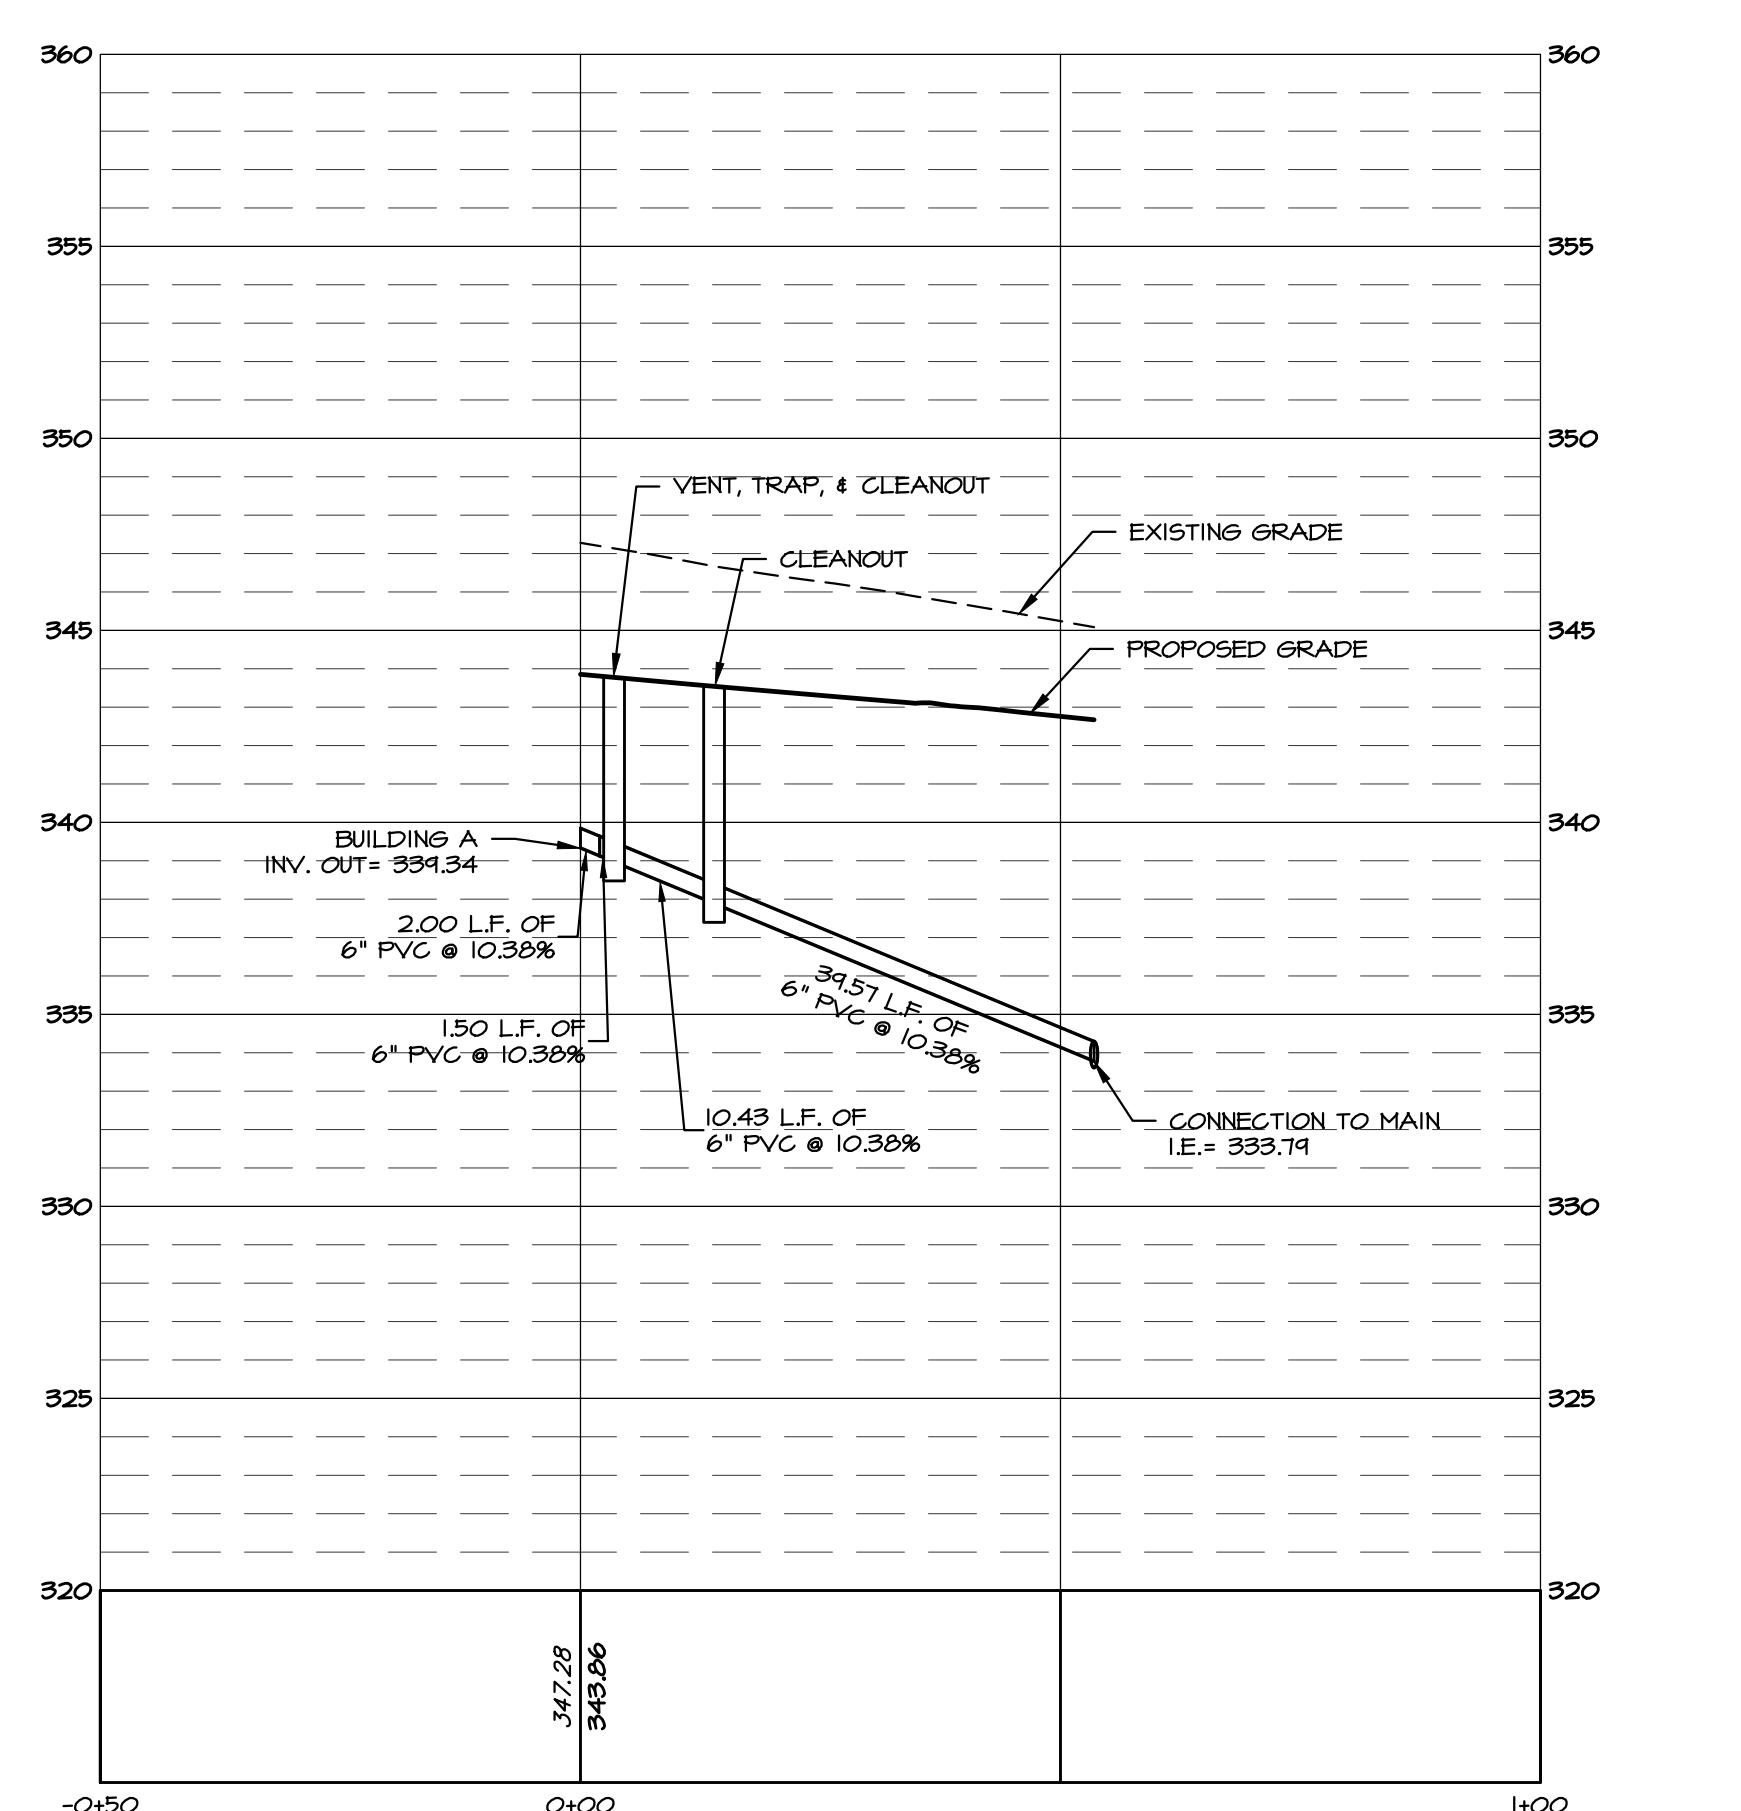
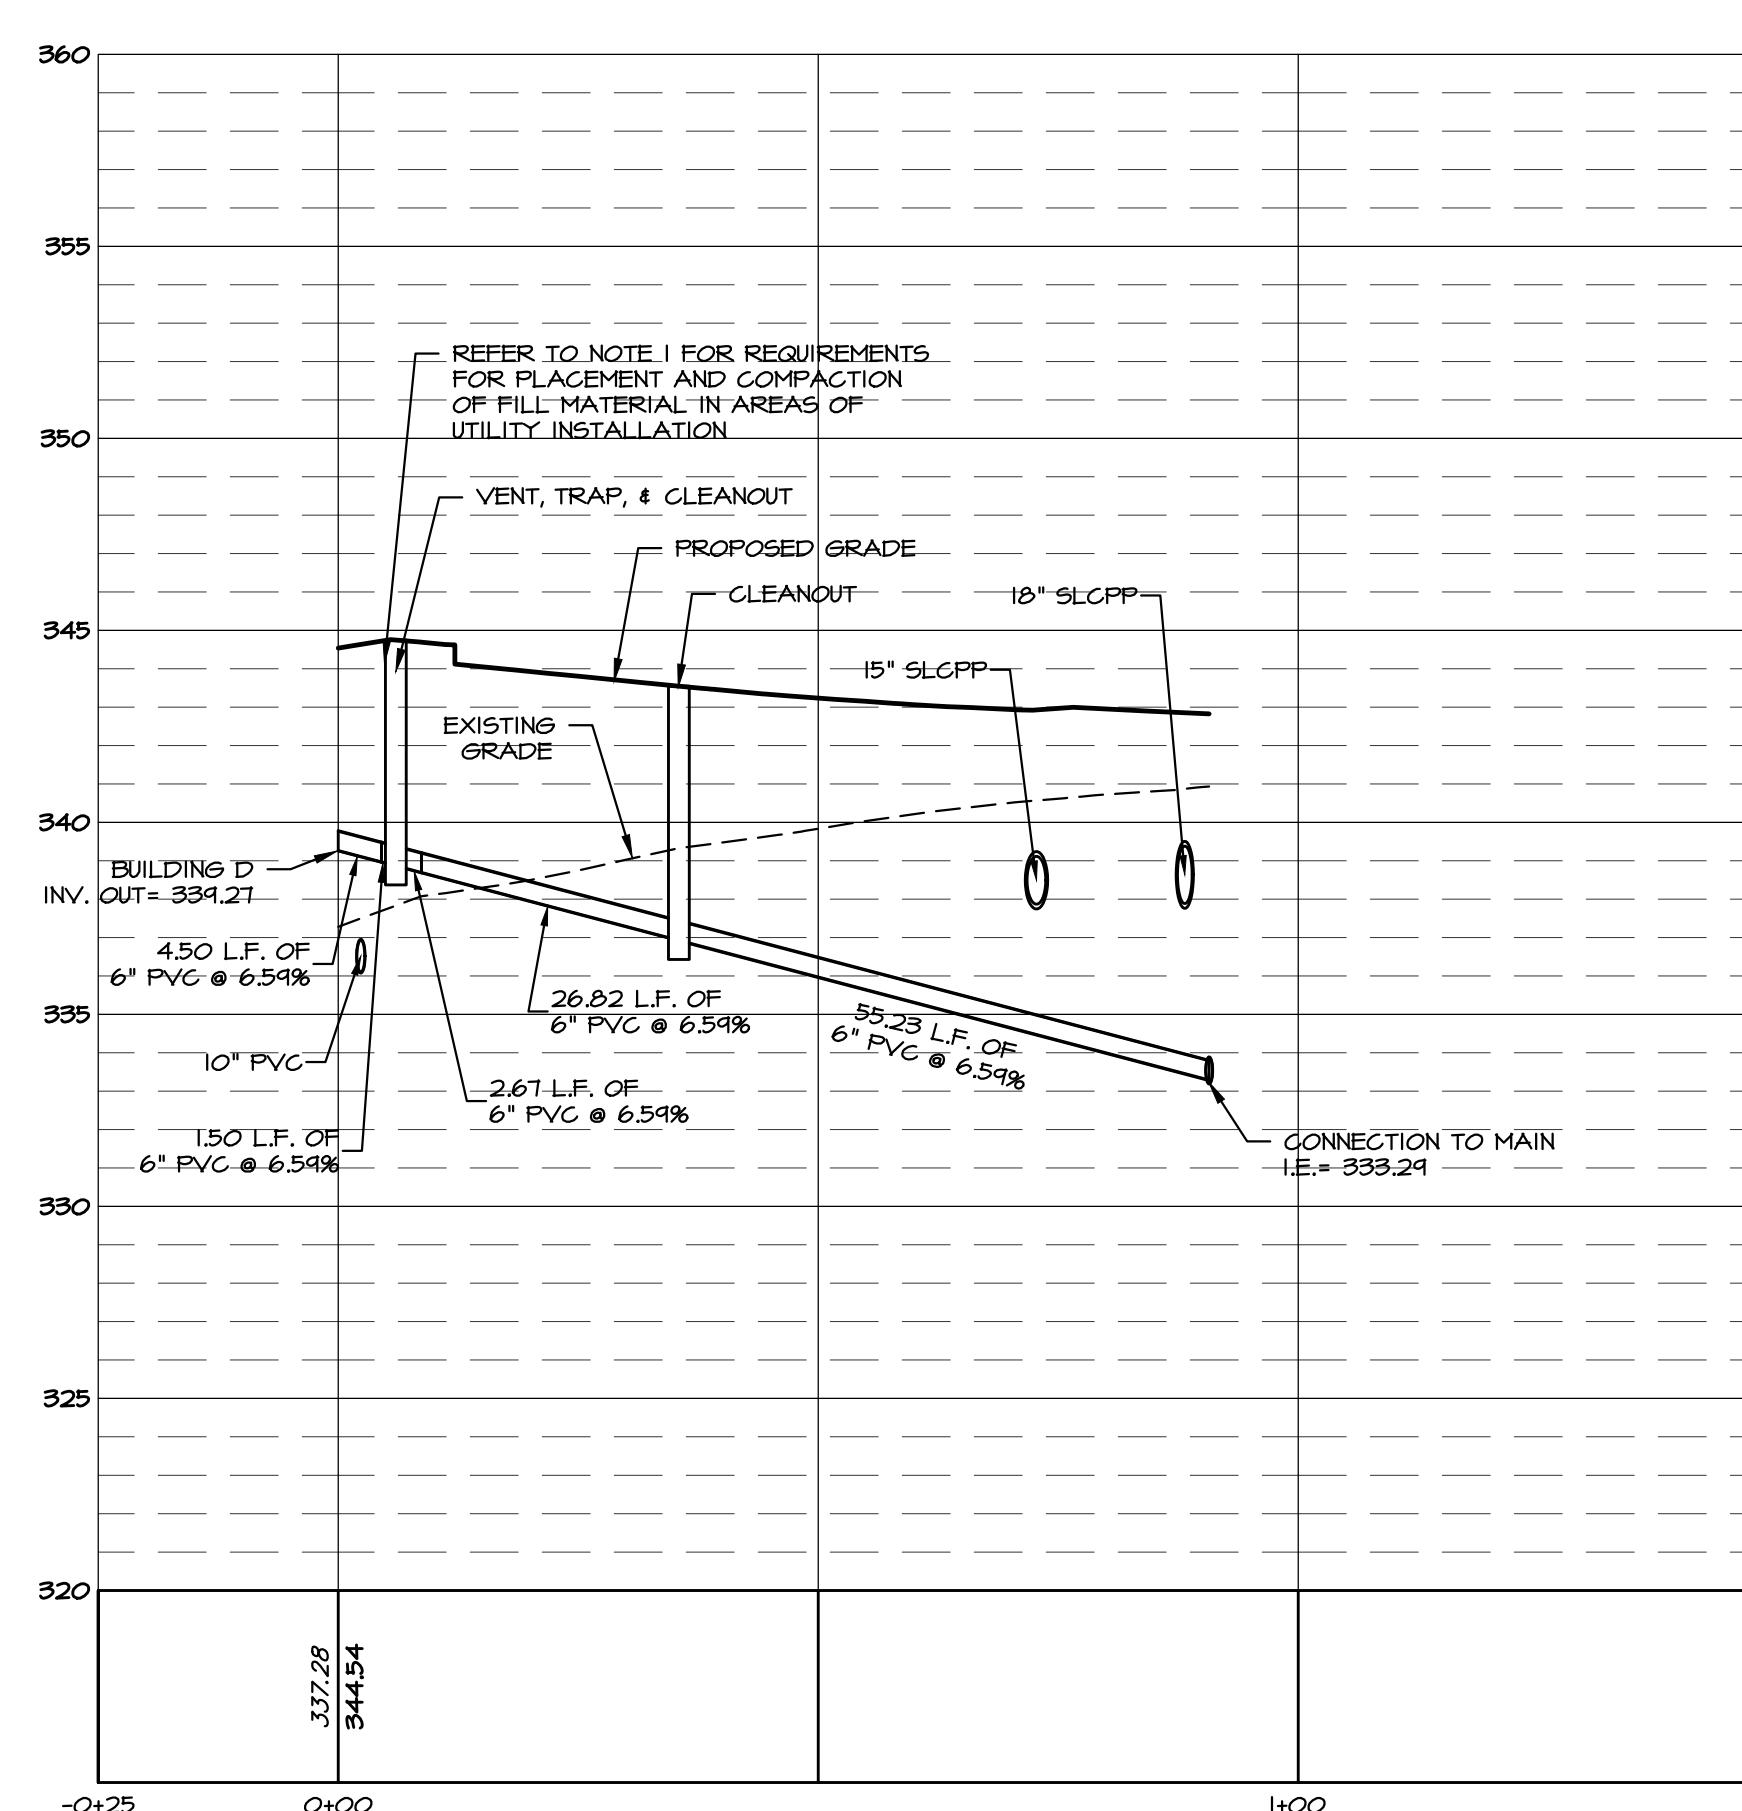
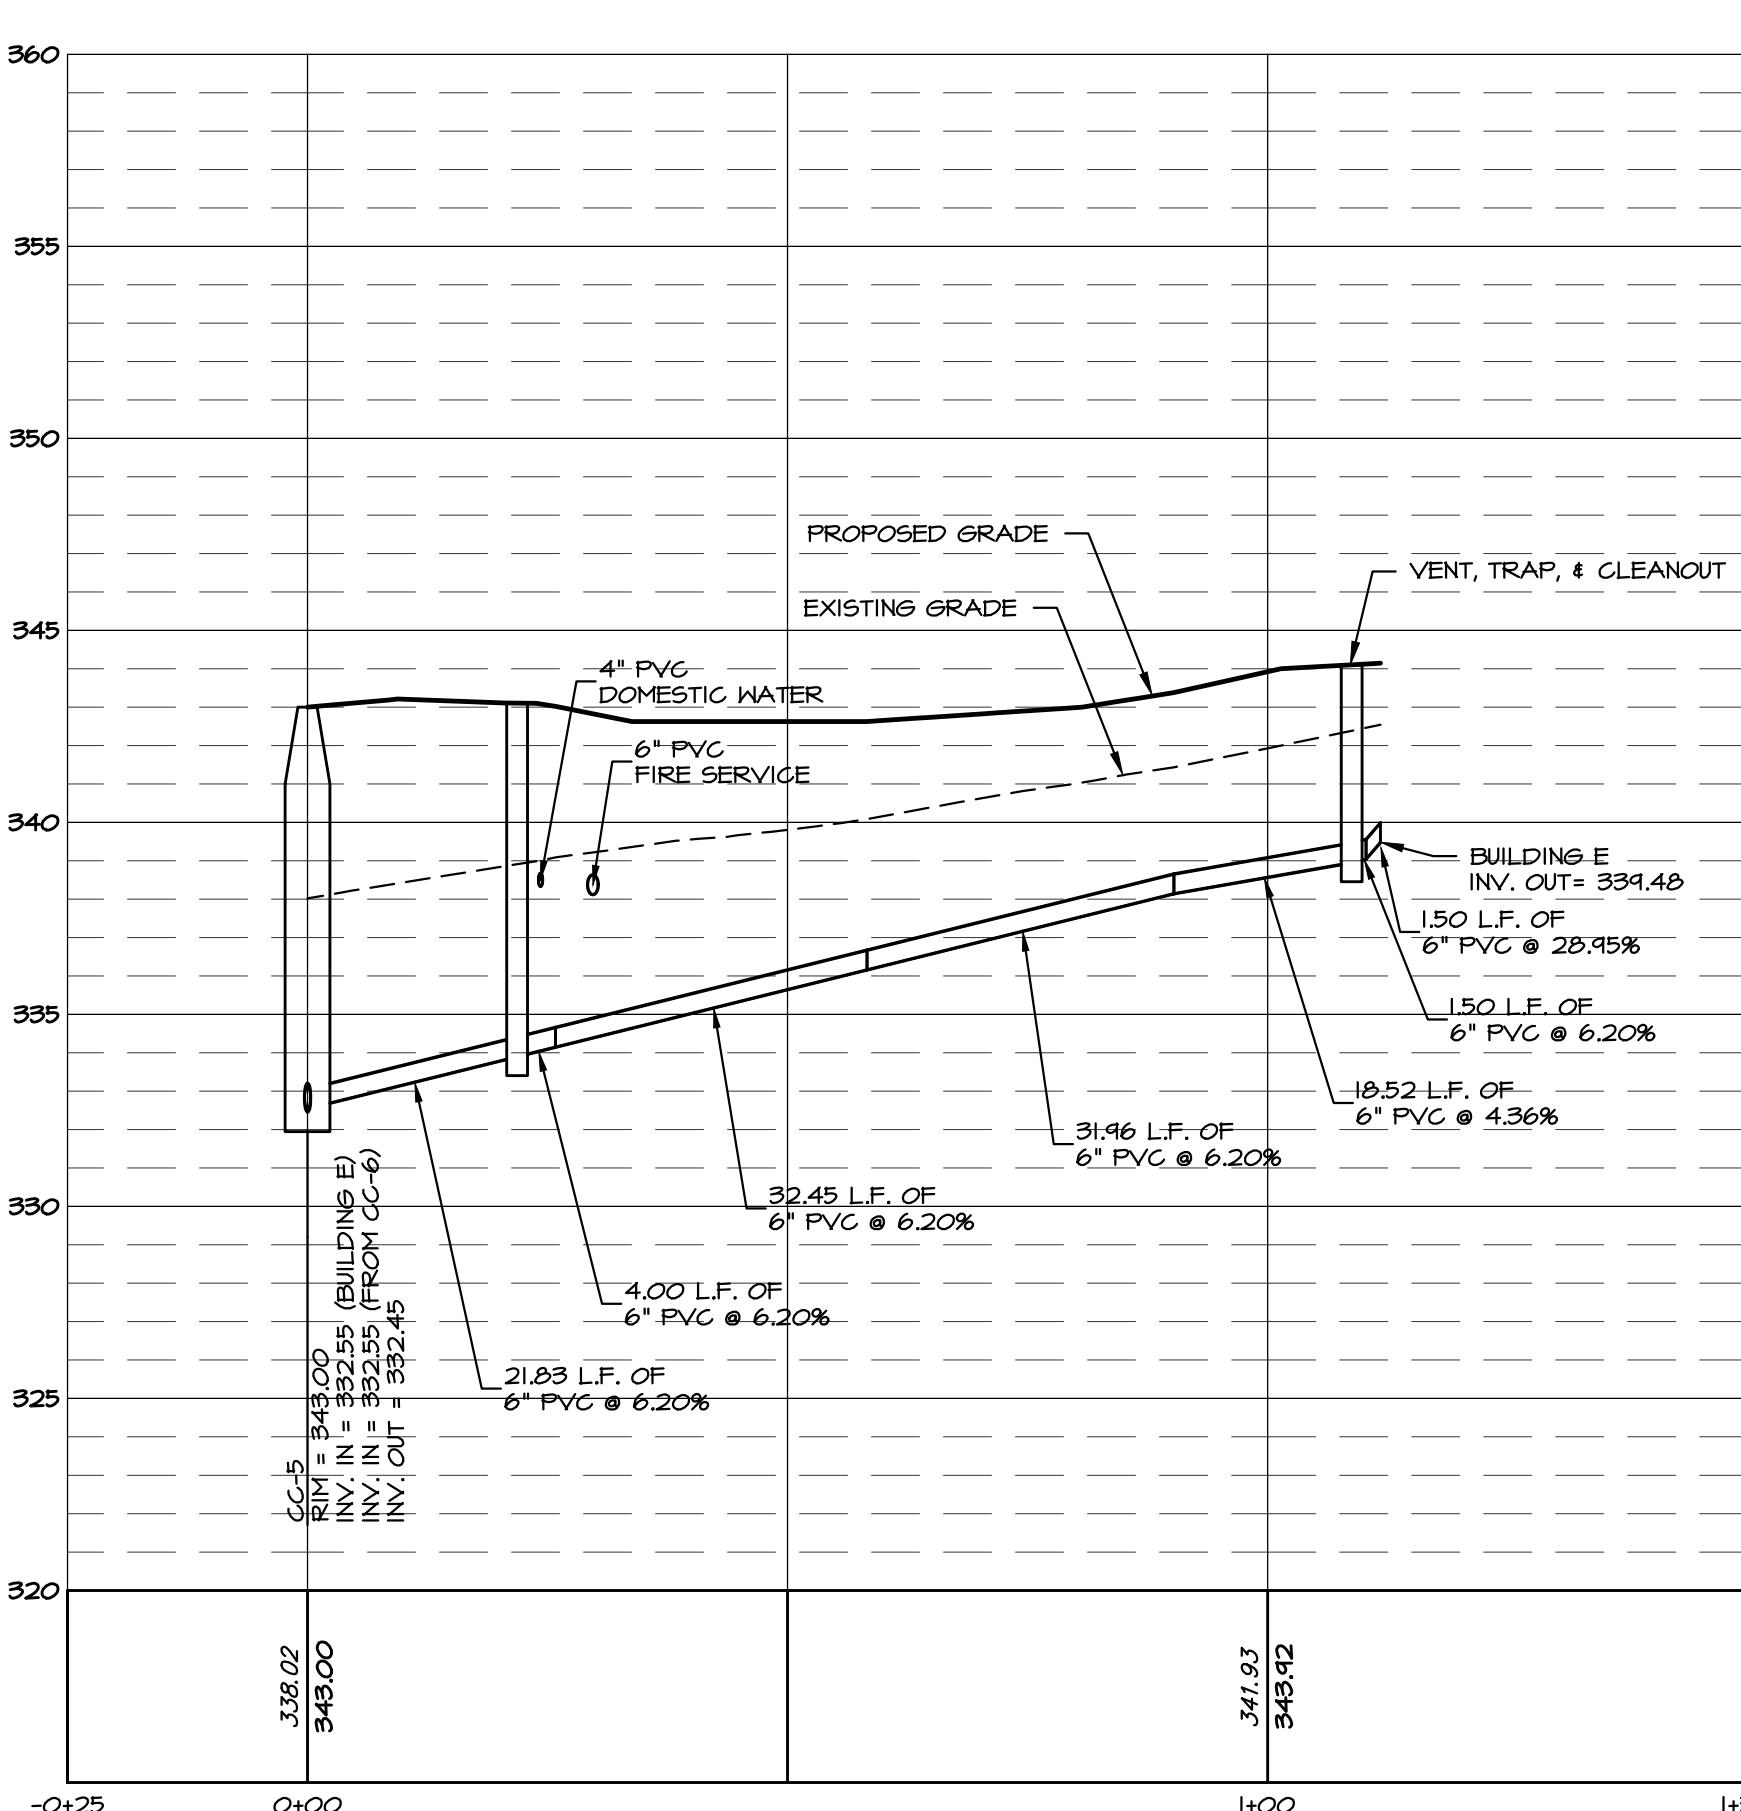
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group, inc.  
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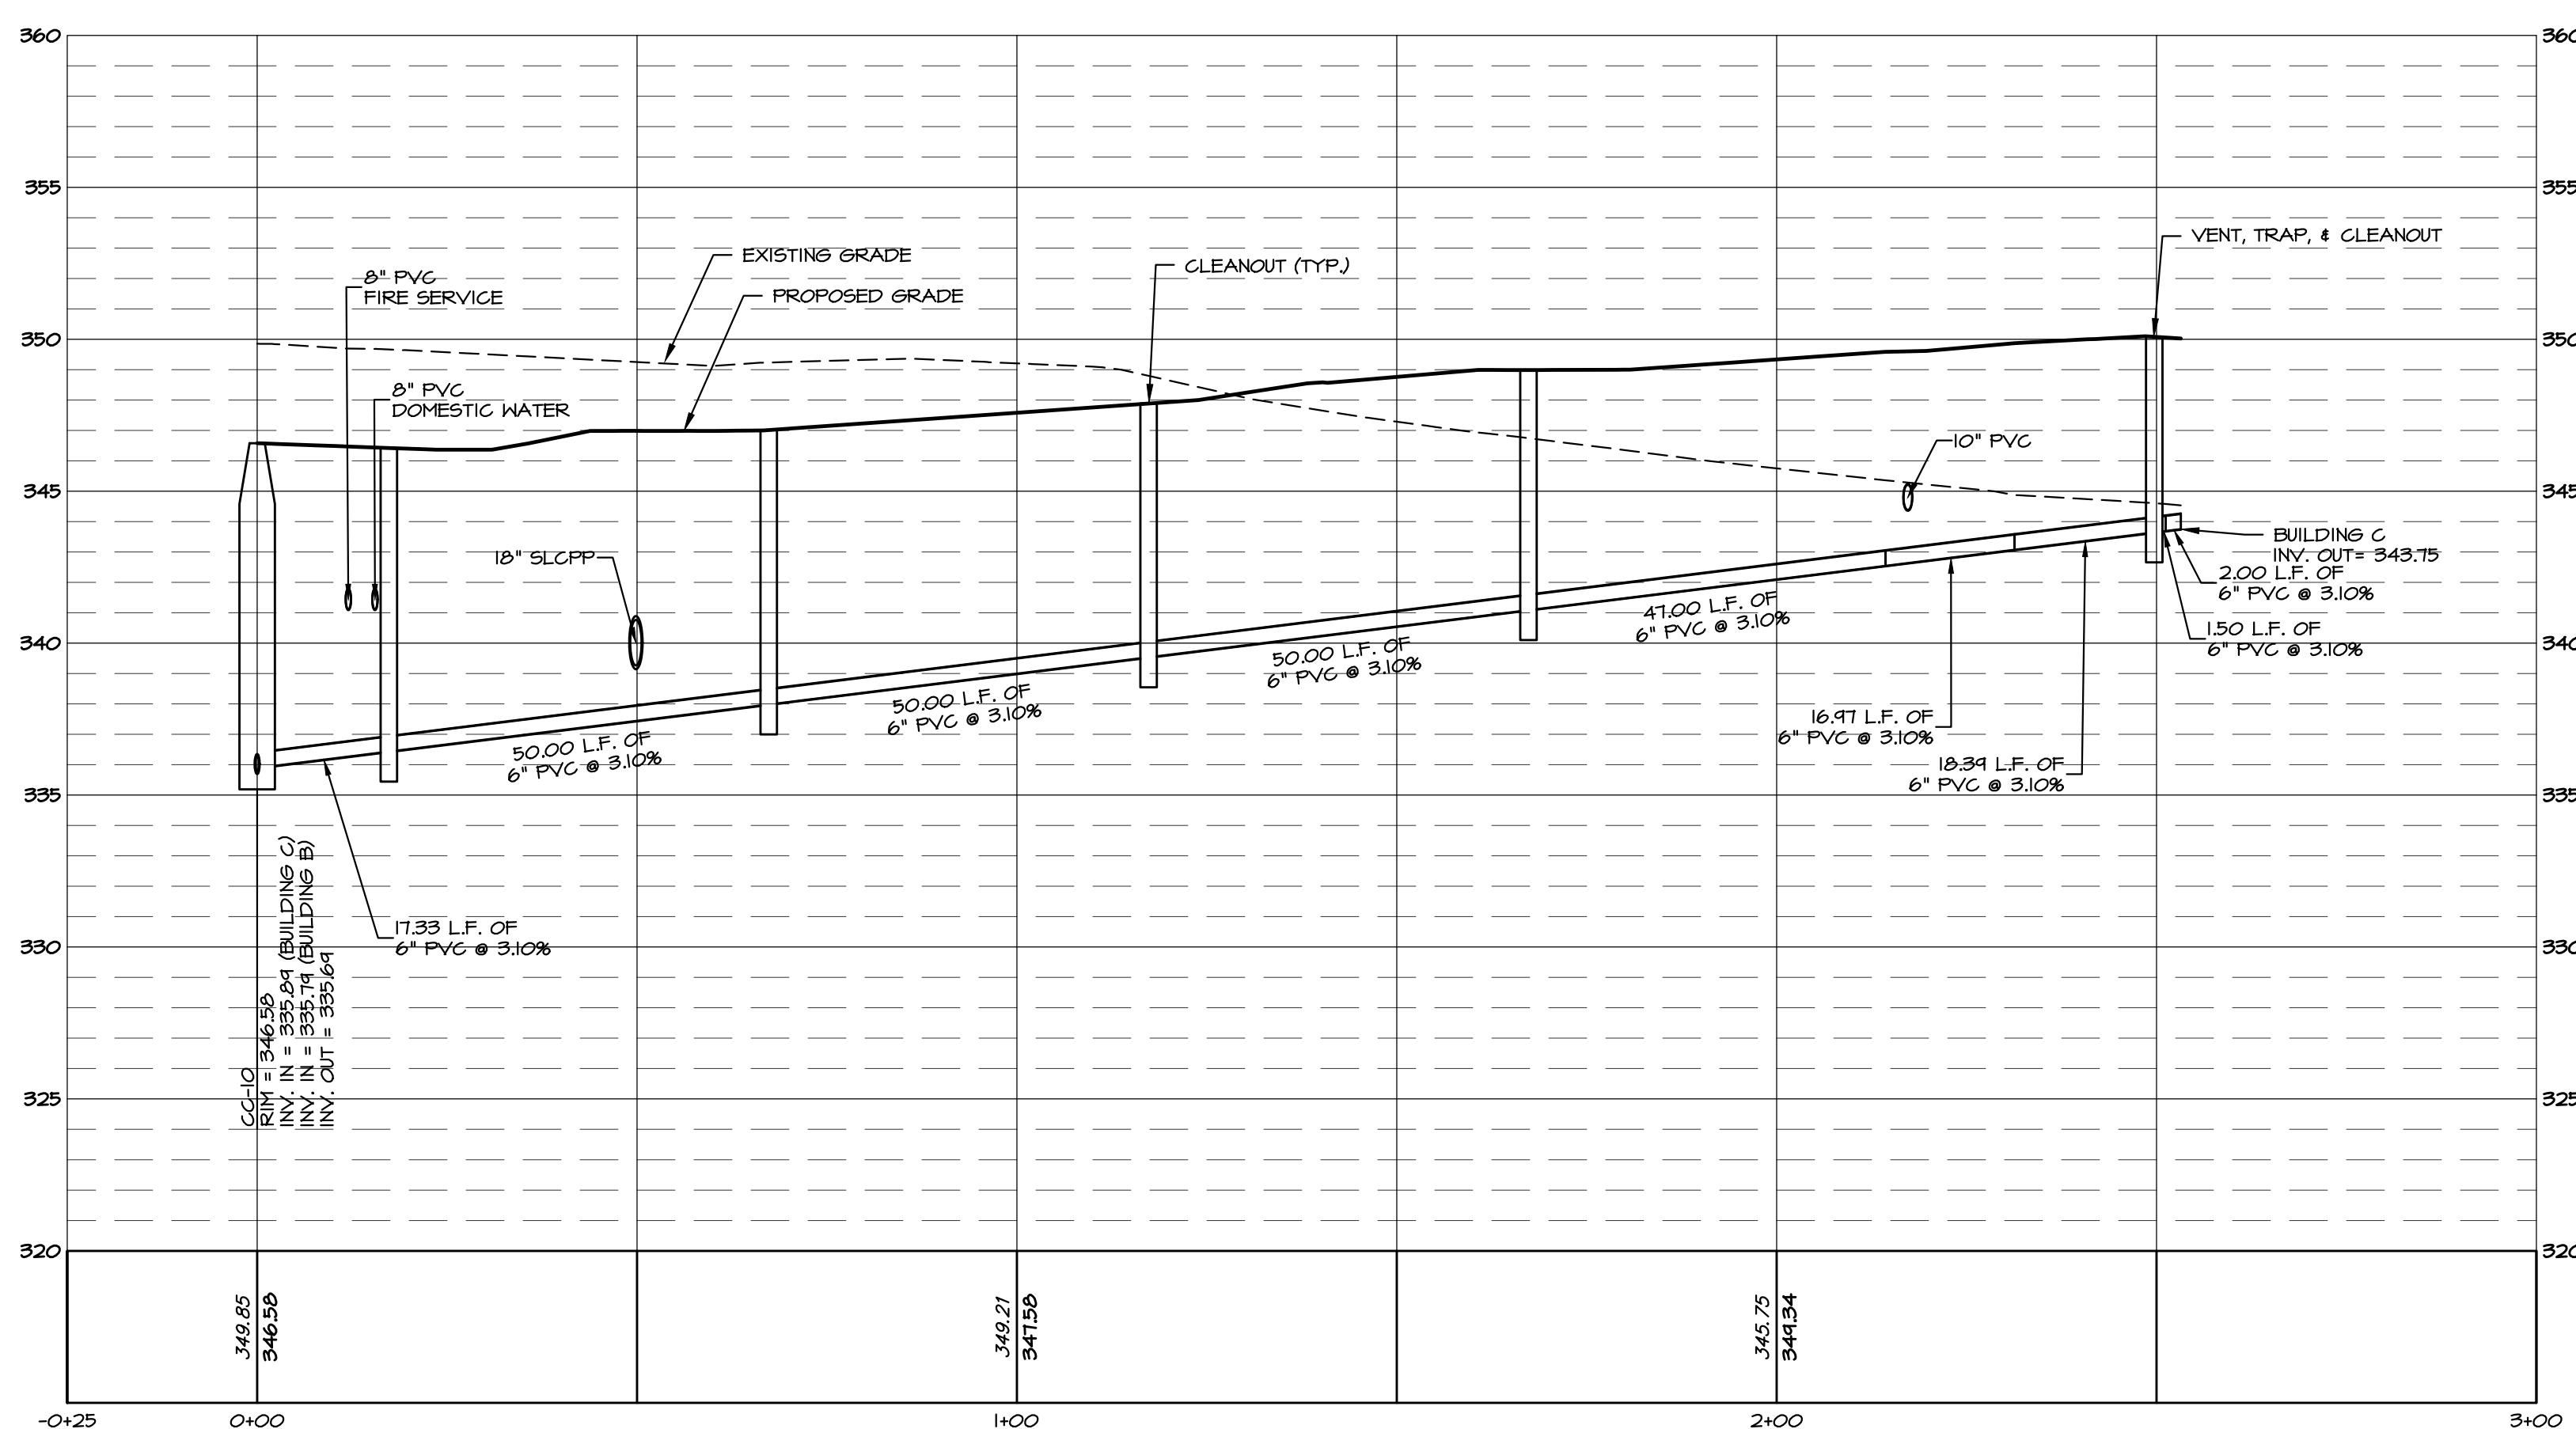
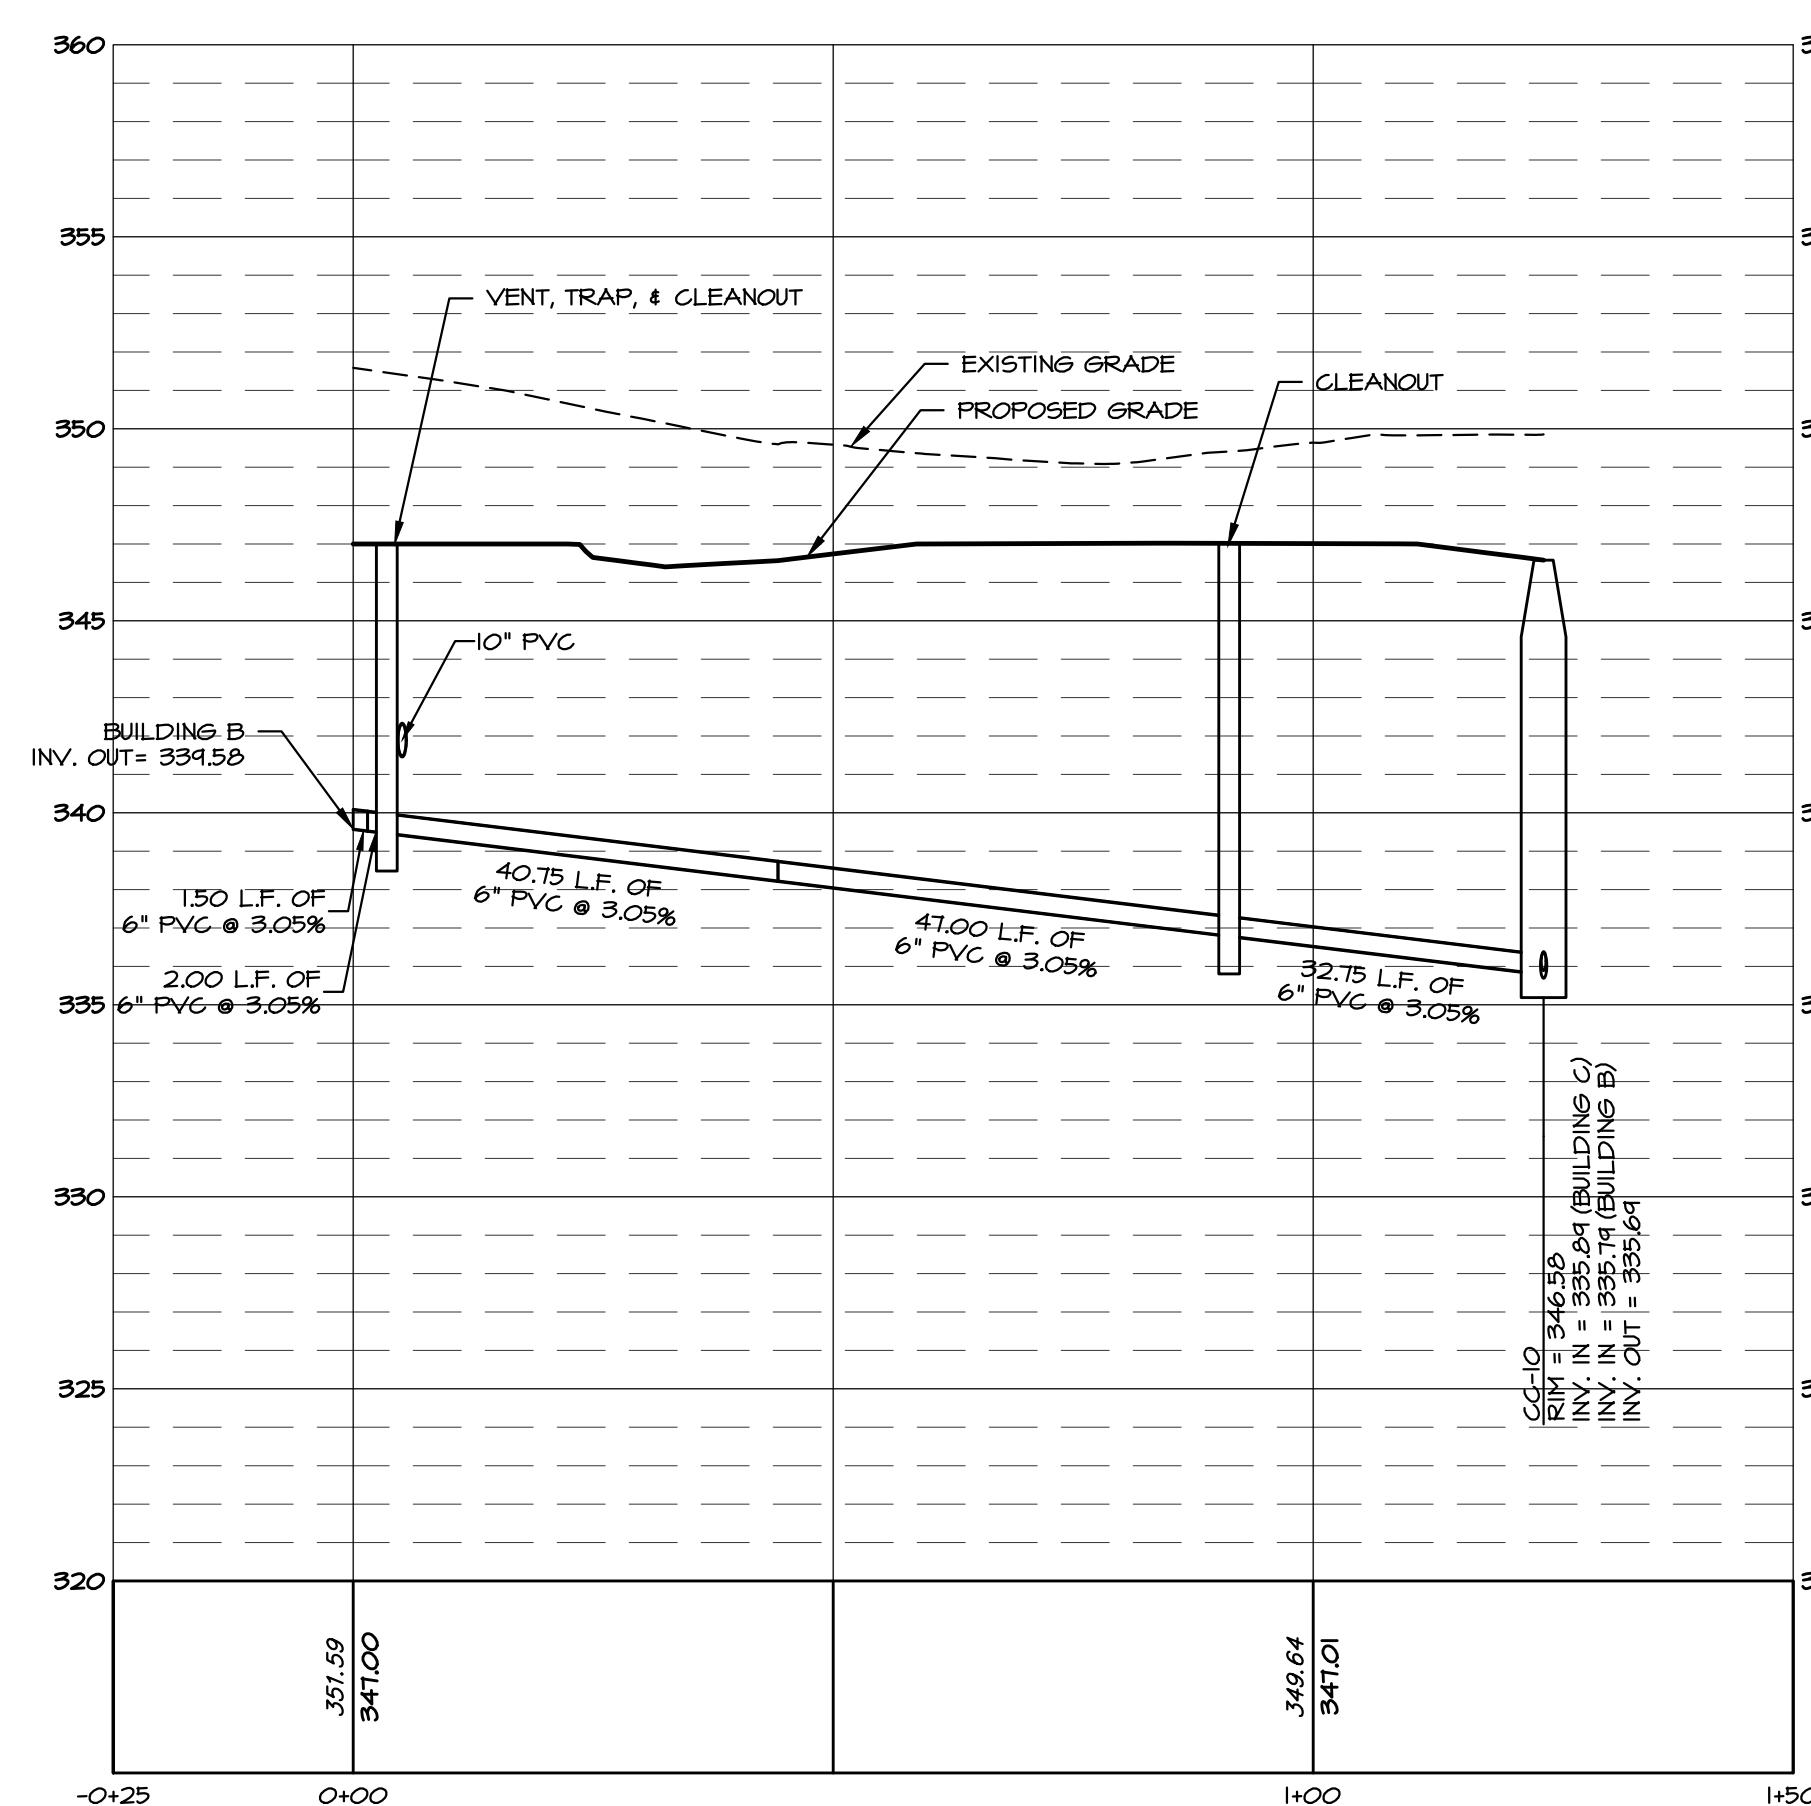
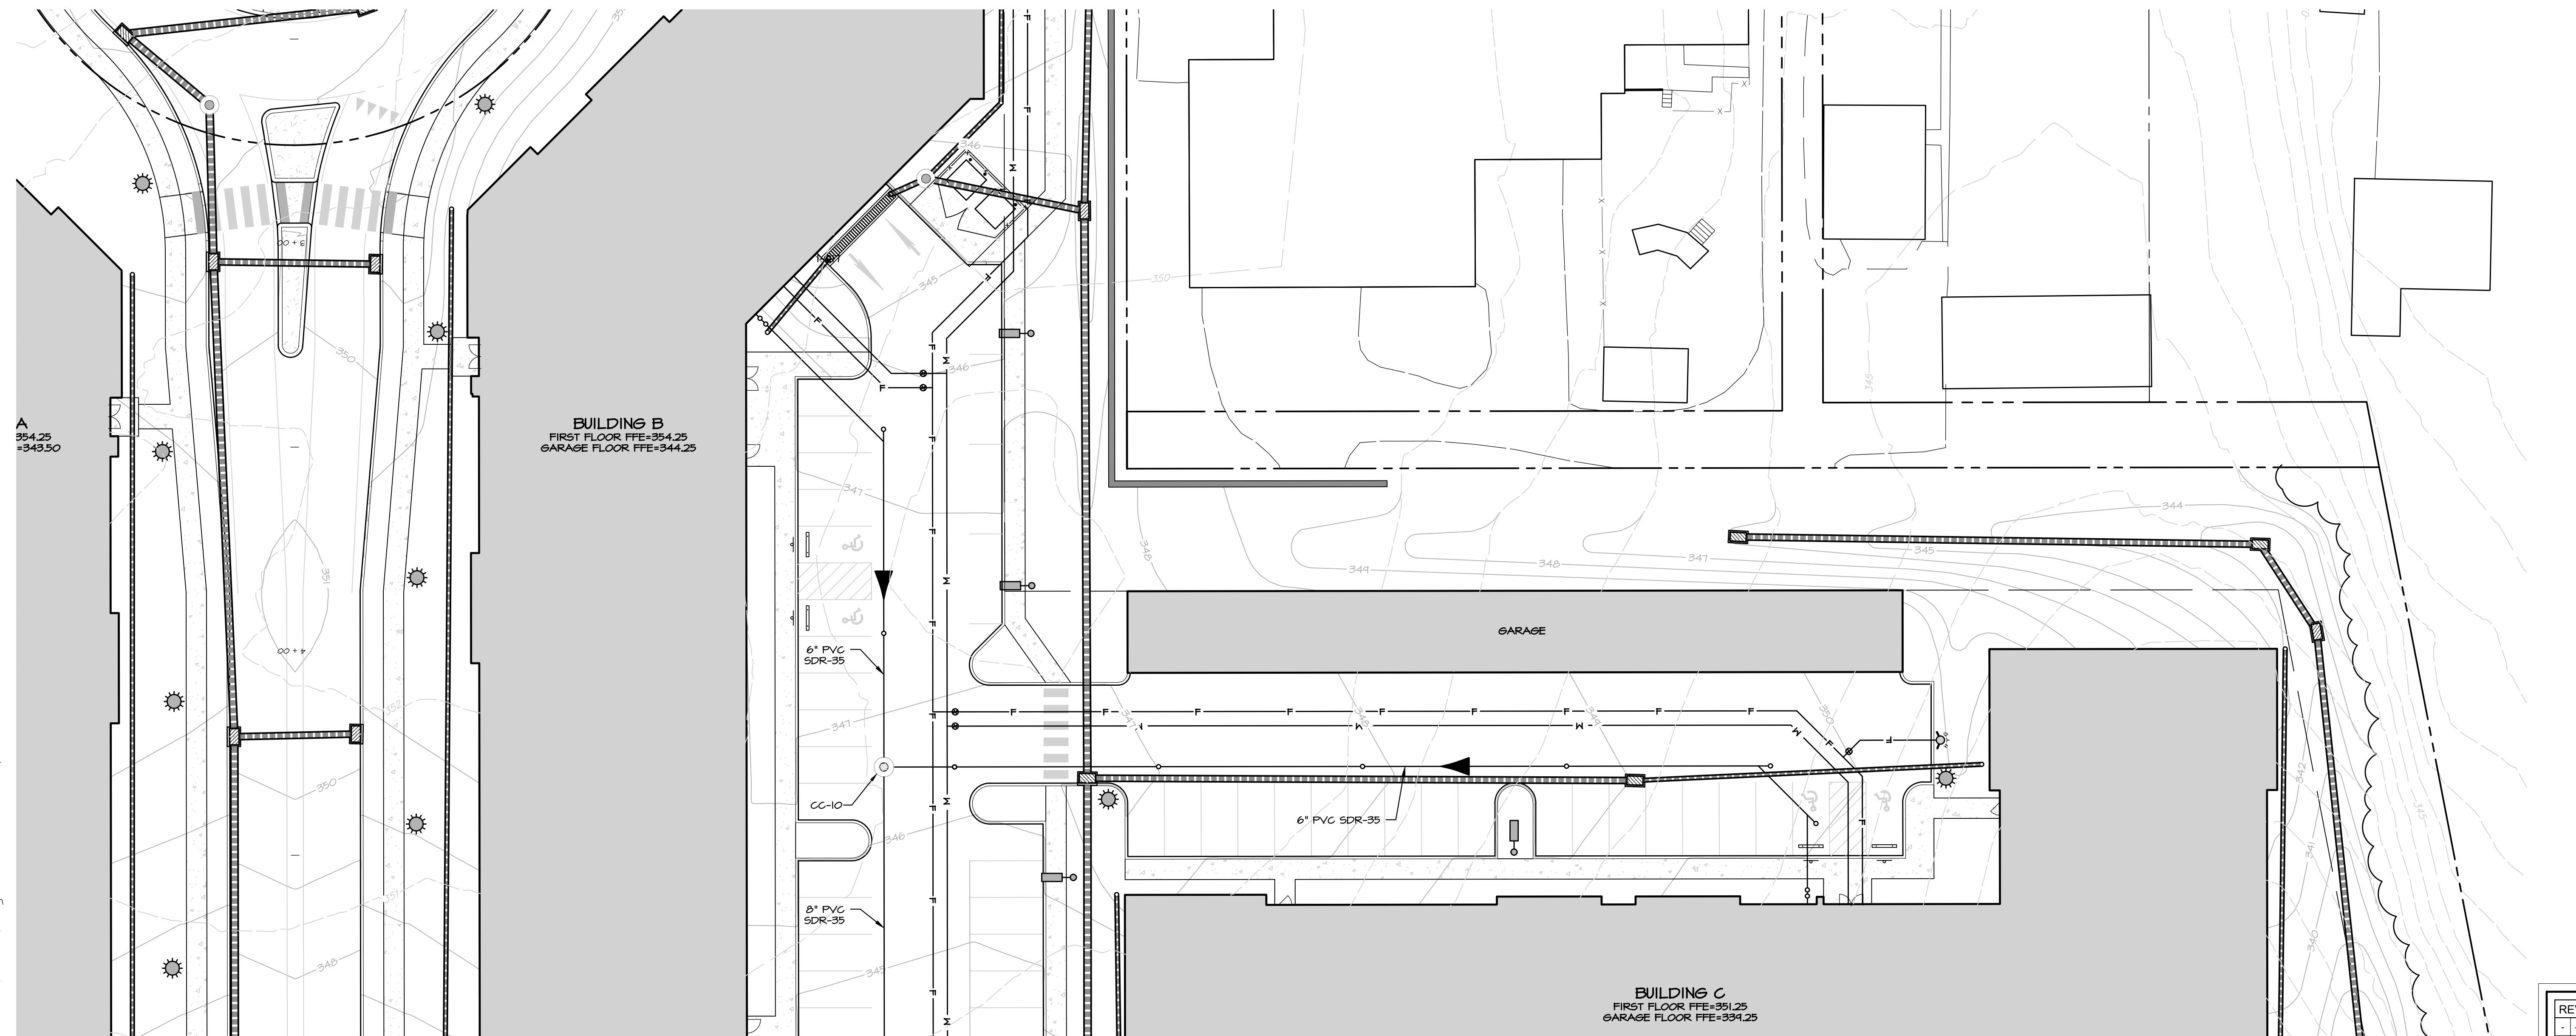
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**CONDITIONAL USE PLAN**  
SUBJECT:  
**UTILITY PLAN & PROFILES**  
FOR  
CHIQUES CROSSING  
RAPHO TOWNSHIP, LANCASTER COUNTY, PENNSYLVANIA  
CLIENT:  
VISTABLOCK, LLC  
150 FARMINGTON LANE  
LANCASTER, PA 17601  
717-682-8775

MANAGER: BDG DATE: JAN 5, 2024  
DESIGNER: DJM PROJECT NO. 1212-002  
DRAWN BY: BLM SCALE: AS SHOWN



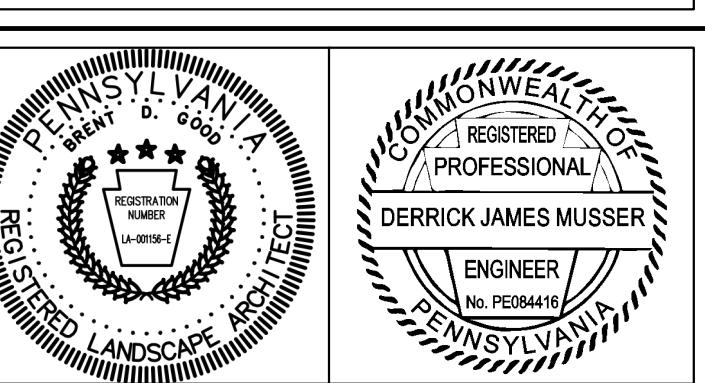

BUILDING B SEWER LATERAL


BUILDING C SEWER LATERAL

REVISIONS PER:		DATE:	BY:
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43 S. BROAD ST.  
LITITZ, PA 17543  
(717) 626-7271

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## **CONDITIONAL USE PLAN**

**CONDITIONAL USE PLAN  
SUBJECT:  
UTILITY PLAN & PROFILES  
FOR**

**CLIENT:**  
**VICTARILOCK LLC**

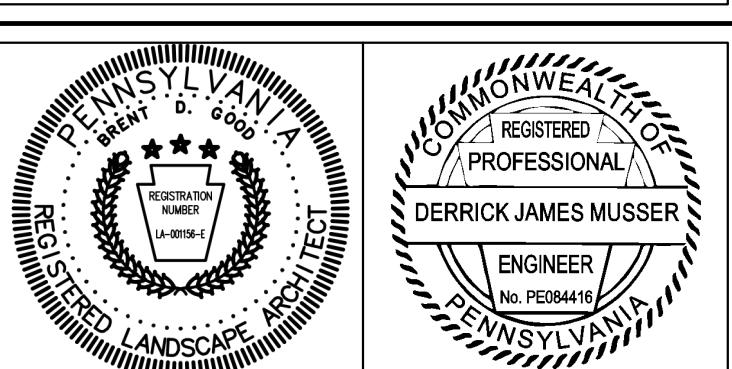VISTABLOCK, LLC  
150 FARMINGTON LANE  
LANCASTER, PA 17601  
717-682-8775

GER: BDG DATE: JAN. 5, 2024

OWNER: DJM PROJECT NO. 1212-0

N BY: BLM SCALE: AS SHOW


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500178

DRAWING NO.  
**50 of 78**

DRAWING NO.  
**50 of 78**






- NOTES:**
- BITUMINOUS PAVEMENT MATERIALS ARE LISTED PER PENNSYLVANIA DEPARTMENT OF TRANSPORTATION, PUBLICATION 408 STANDARDS, LATEST REVISIONS.
  - RECLAIMED AGGREGATE MATERIAL SHALL MEET THE REQUIREMENTS OF PA DOT PUBLICATION 408, SECTION 703.1, TABLE A, OR 703.2, TABLE B.
  - IT IS RECOMMENDED THAT THE PAVEMENT SECTION AND OTHER DESIGN CONSIDERATIONS SUCH AS PAVEMENT BASE DRAIN BE DESIGNED BY A GEOTECHNICAL PROFESSIONAL BASED UPON FIELD TESTING OF SOIL SUBGRADE, CONDITIONS ANTICIPATED PAVEMENT LOADING, INCLUDING CONSTRUCTION TRAFFIC, AND OTHER APPROPRIATE DESIGN FACTORS. THE PAVEMENT SECTION SPECIFIED ON THIS DRAWING IS PROVIDED WITHOUT A GEOTECHNICAL PROFESSIONAL AND REPRESENTS A STANDARD PAVEMENT SECTION THAT DOES NOT CONSIDER THESE FACTORS.\*
  - THE SUITABILITY OF THE PAVEMENT SUBGRADE SHALL BE INSPECTED AND APPROVED BY GEOTECHNICAL PROFESSIONAL PRIOR TO INSTALLATION OF PAVING SECTION. IF SUBGRADE IS DETERMINED UNSUITABLE BASED UPON COMPACTION, SOIL TYPE ETC., APPROPRIATE STABILIZATION MEASURES AS RECOMMENDED BY THE GEOTECHNICAL PROFESSIONAL SHALL BE IMPLEMENTED.
  - IF ANY PRECIPITATION OCCURS BEFORE STONE SUBBASE INSTALLATION, PAVING SUBGRADE SHALL MUST BE RE-INSPECTED AND APPROVED TO CONFIRM SUITABILITY.
  - SPECIFIC PAVING CRITERIA AS CONTAINED WITHIN PENDOT PUBLICATION 408 AS IT RELATES TO APPROVED AMBIENT TEMPERATURE FOR PAVING INSTALLATION SHALL BE FOLLOWED.

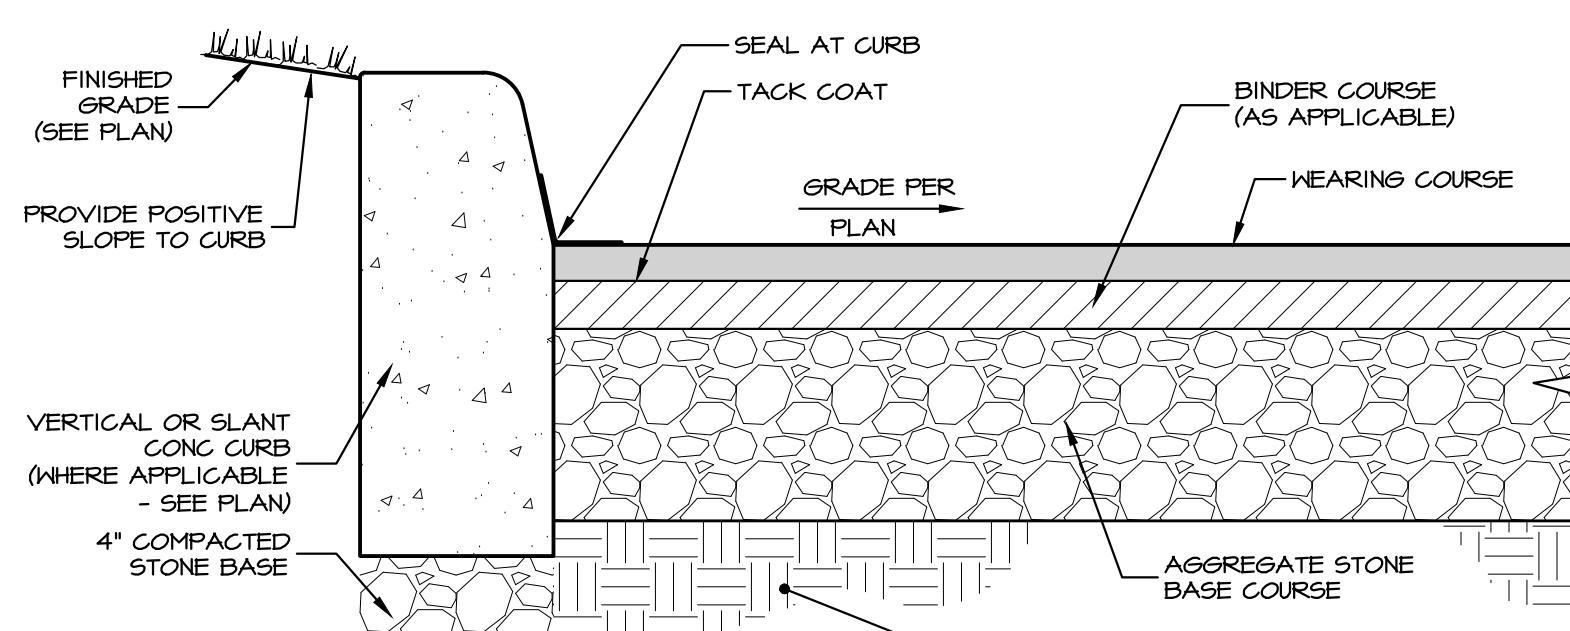**BITUMINOUS PAVING SCHEDULE**


SYM	WEARING COURSE		BINDER COURSE		AGGREGATE BASE COURSE		LOCATION
	TYPE	COMPACTED THICKNESS	TYPE	COMPACTED THICKNESS	TYPE	COMPACTED THICKNESS	
A	SUPERPAVE ASPHALT DESIGN HMA WEARING COURSE, PG 64-22, 0.0 TO 0.3 MILLION ESAL'S, 9.5 MM, SRL-L	15"	SUPERPAVE ASPHALT DESIGN HMA BINDER COURSE, PG 64-22, 0.0 TO 0.3 MILLION ESAL'S, 25 MM MIX, 50 GYRATIONS	4"	3A MODIFIED	10"	ACCESS DRIVES
B	SUPERPAVE ASPHALT DESIGN HMA WEARING COURSE, PG 64-22, 0.0 TO 0.3 MILLION ESAL'S, 9.5 MM, SRL-L	15"	SUPERPAVE ASPHALT DESIGN HMA BINDER COURSE, PG 64-22, 0.0 TO 0.3 MILLION ESAL'S, 25 MM MIX, 50 GYRATIONS	3.5"	3A MODIFIED	6"	PARKING LOTS

**(A) BITUMINOUS PAVEMENT SECTION / SCHEDULE**


NO SCALE

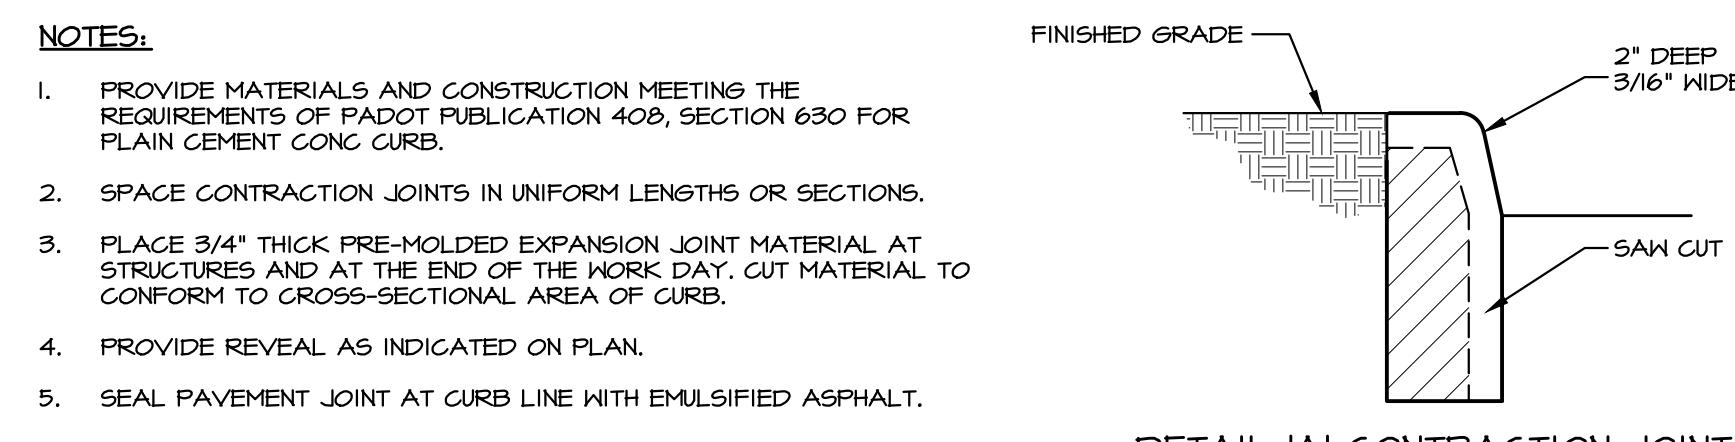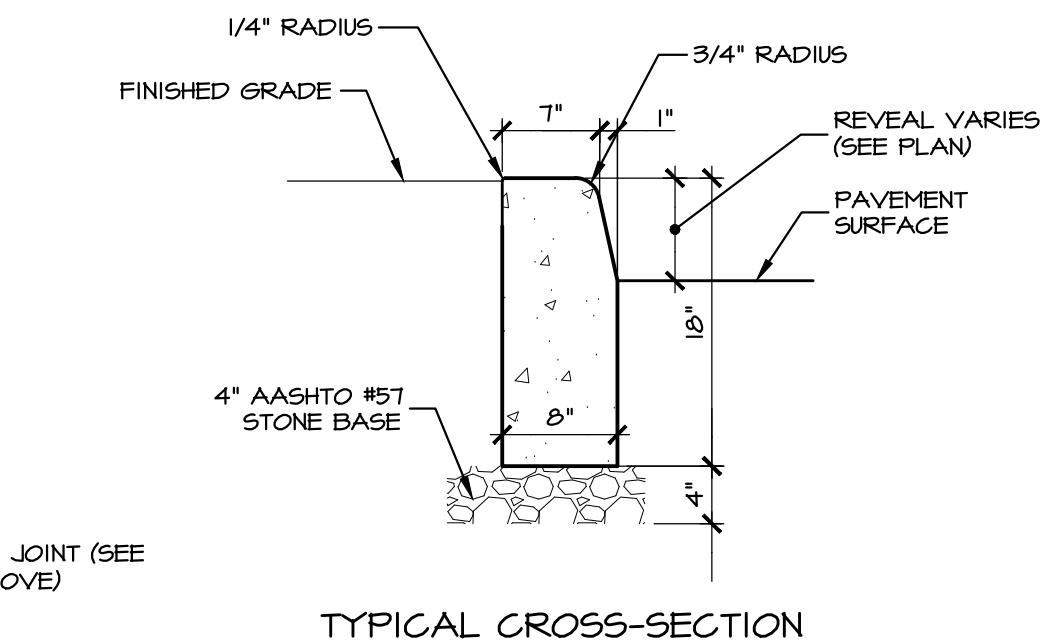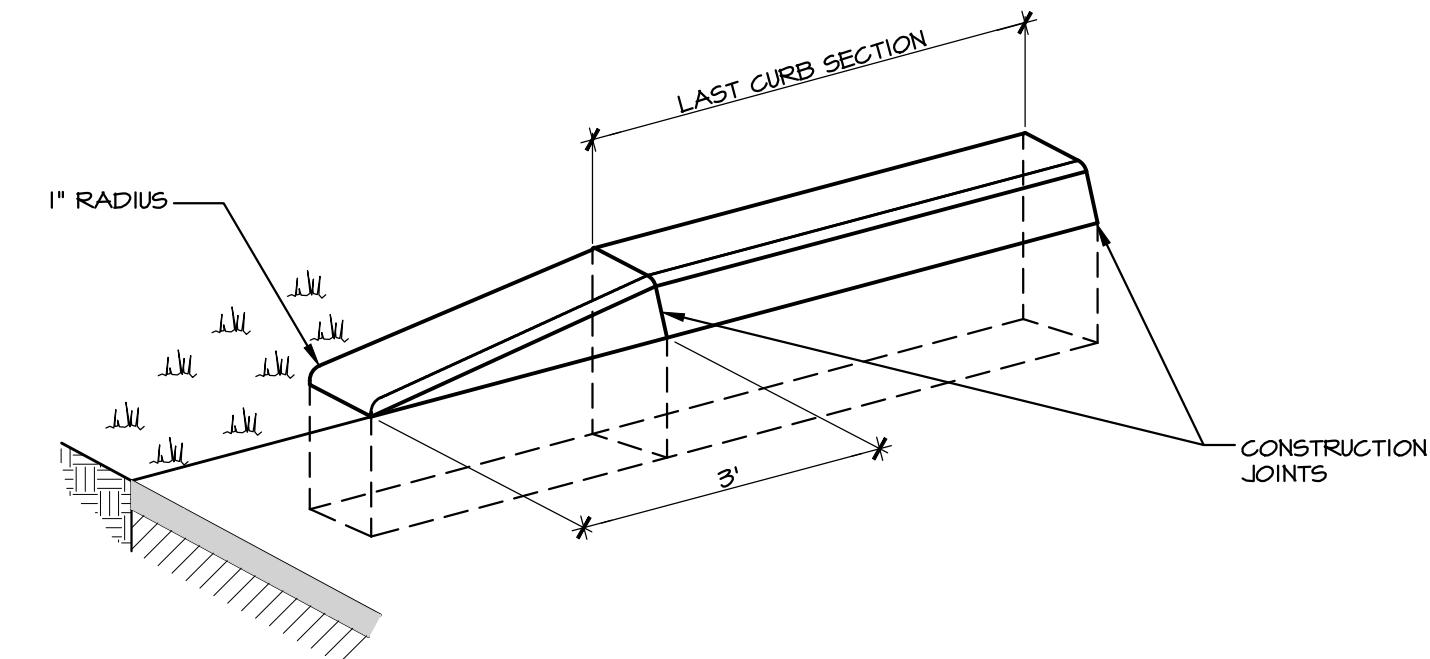**DETAIL 'A' CONTRACTION JOINT****TYPICAL CROSS-SECTION****(C) TYPICAL CURB END DETAIL**


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**TYPICAL EXPANSION & CONTRACTION JOINTS****NOTES:**


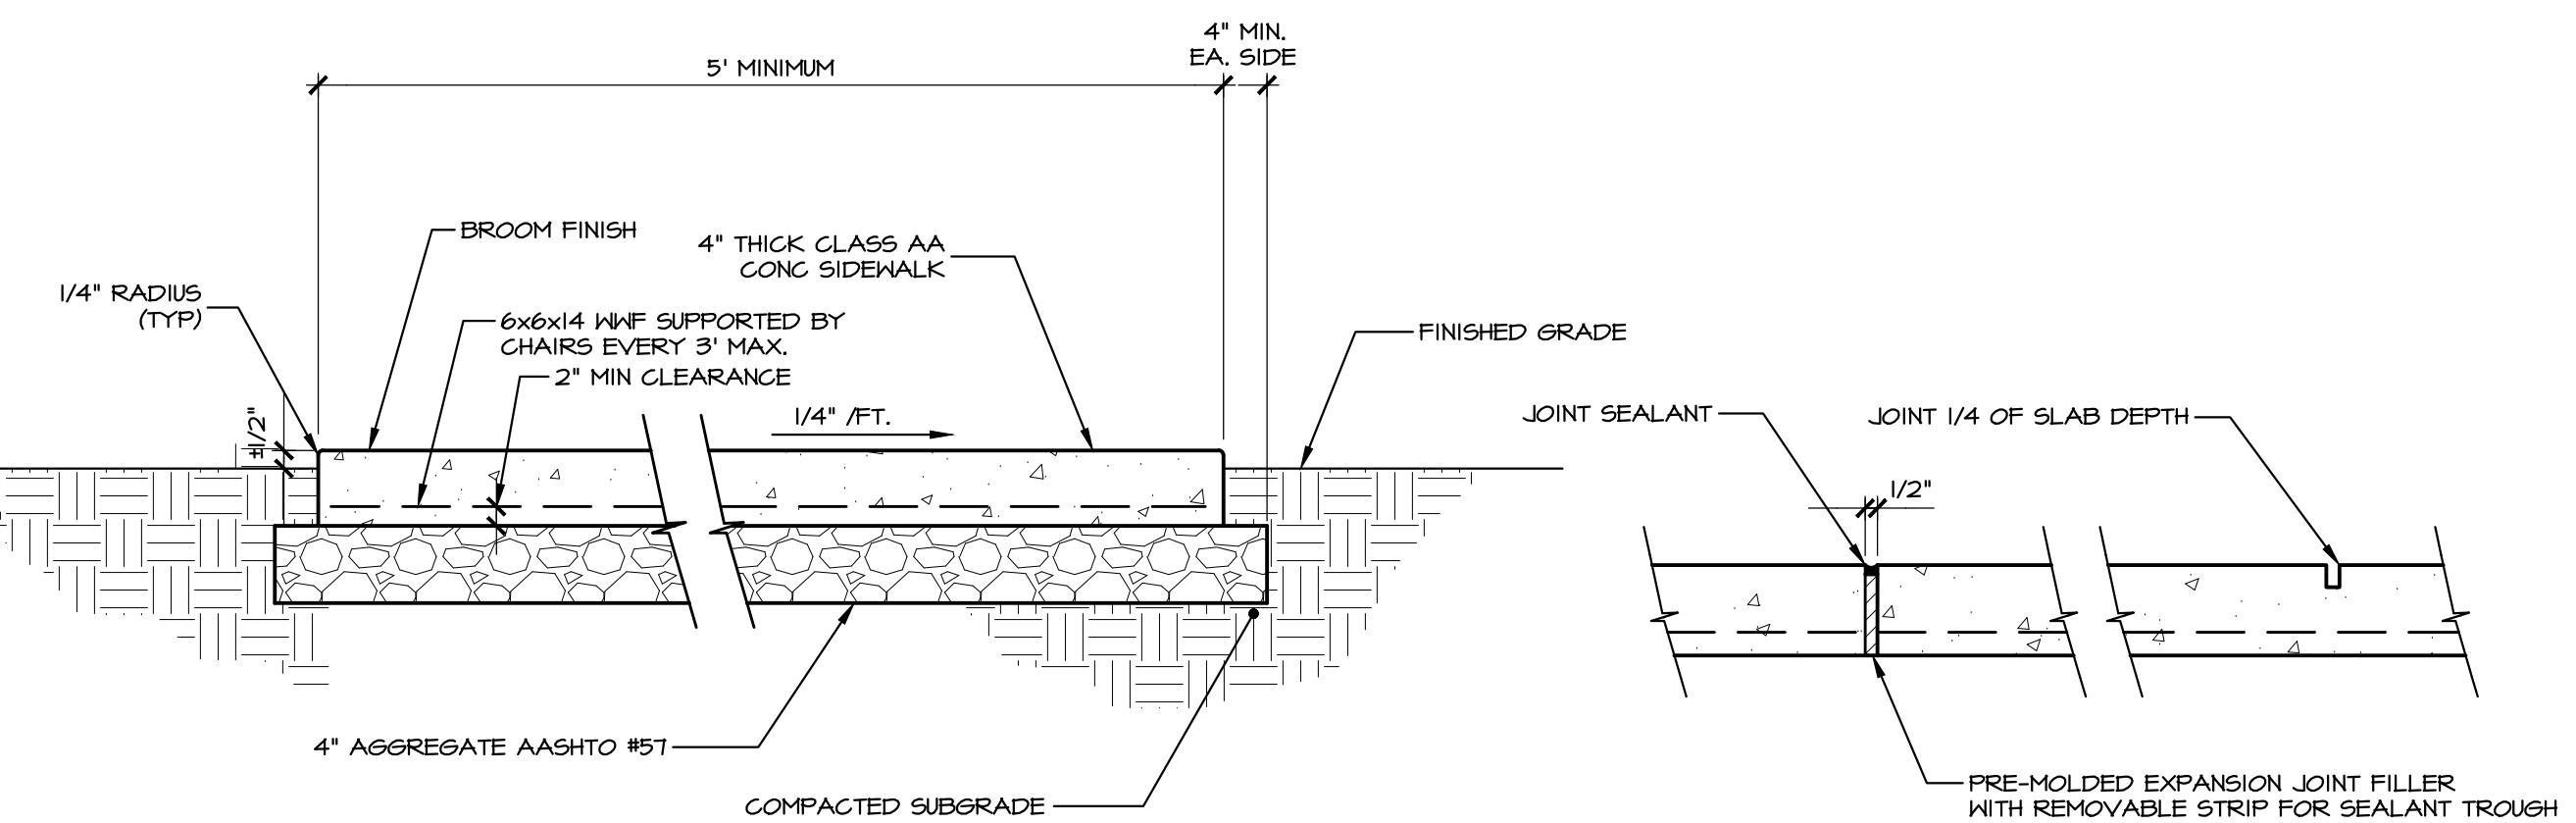
- CONCRETE TO BE PENDOT CLASS A CEMENT. MINIMUM COMPRESSIVE STRENGTH OF 3,000 PSI AT 28 DAYS.
- ALL MATERIALS AND WORKSHIP ARE TO BE IN ACCORDANCE WITH CURRENT PENDOT RC AND PBD 408 STANDARDS.
- TOOLED JOINTED EVERY 5 FEET AND 4" EXPANSION JOINTS 20' O.C.
- PROVIDE 4" EXPANSION JOINT WHERE SIDEWALK IS ADJACENT TO CURB, BUILDING, WALL OR OTHER PERMANENT STRUCTURE FOR ENTIRE LENGTH OF SUCH STRUCTURE.
- DEVELOPER/OWNER/CONTRACTOR TO GUARANTEE SIDEWALK FROM FAILURE FOR 3 YEARS FROM DATE OF COMPLETION.
- SIDEWALK TO BE LIGHT BROOM FINISHED IN THE DIRECTION OF THE SIDEWALK WIDTH.
- UNOBSTRUCTED WIDTH SHALL BE IN ACCORDANCE WITH THE AMERICANS WITH DISABILITIES ACT, AS AMENDED.

**(E) CONCRETE SIDEWALK DETAIL**

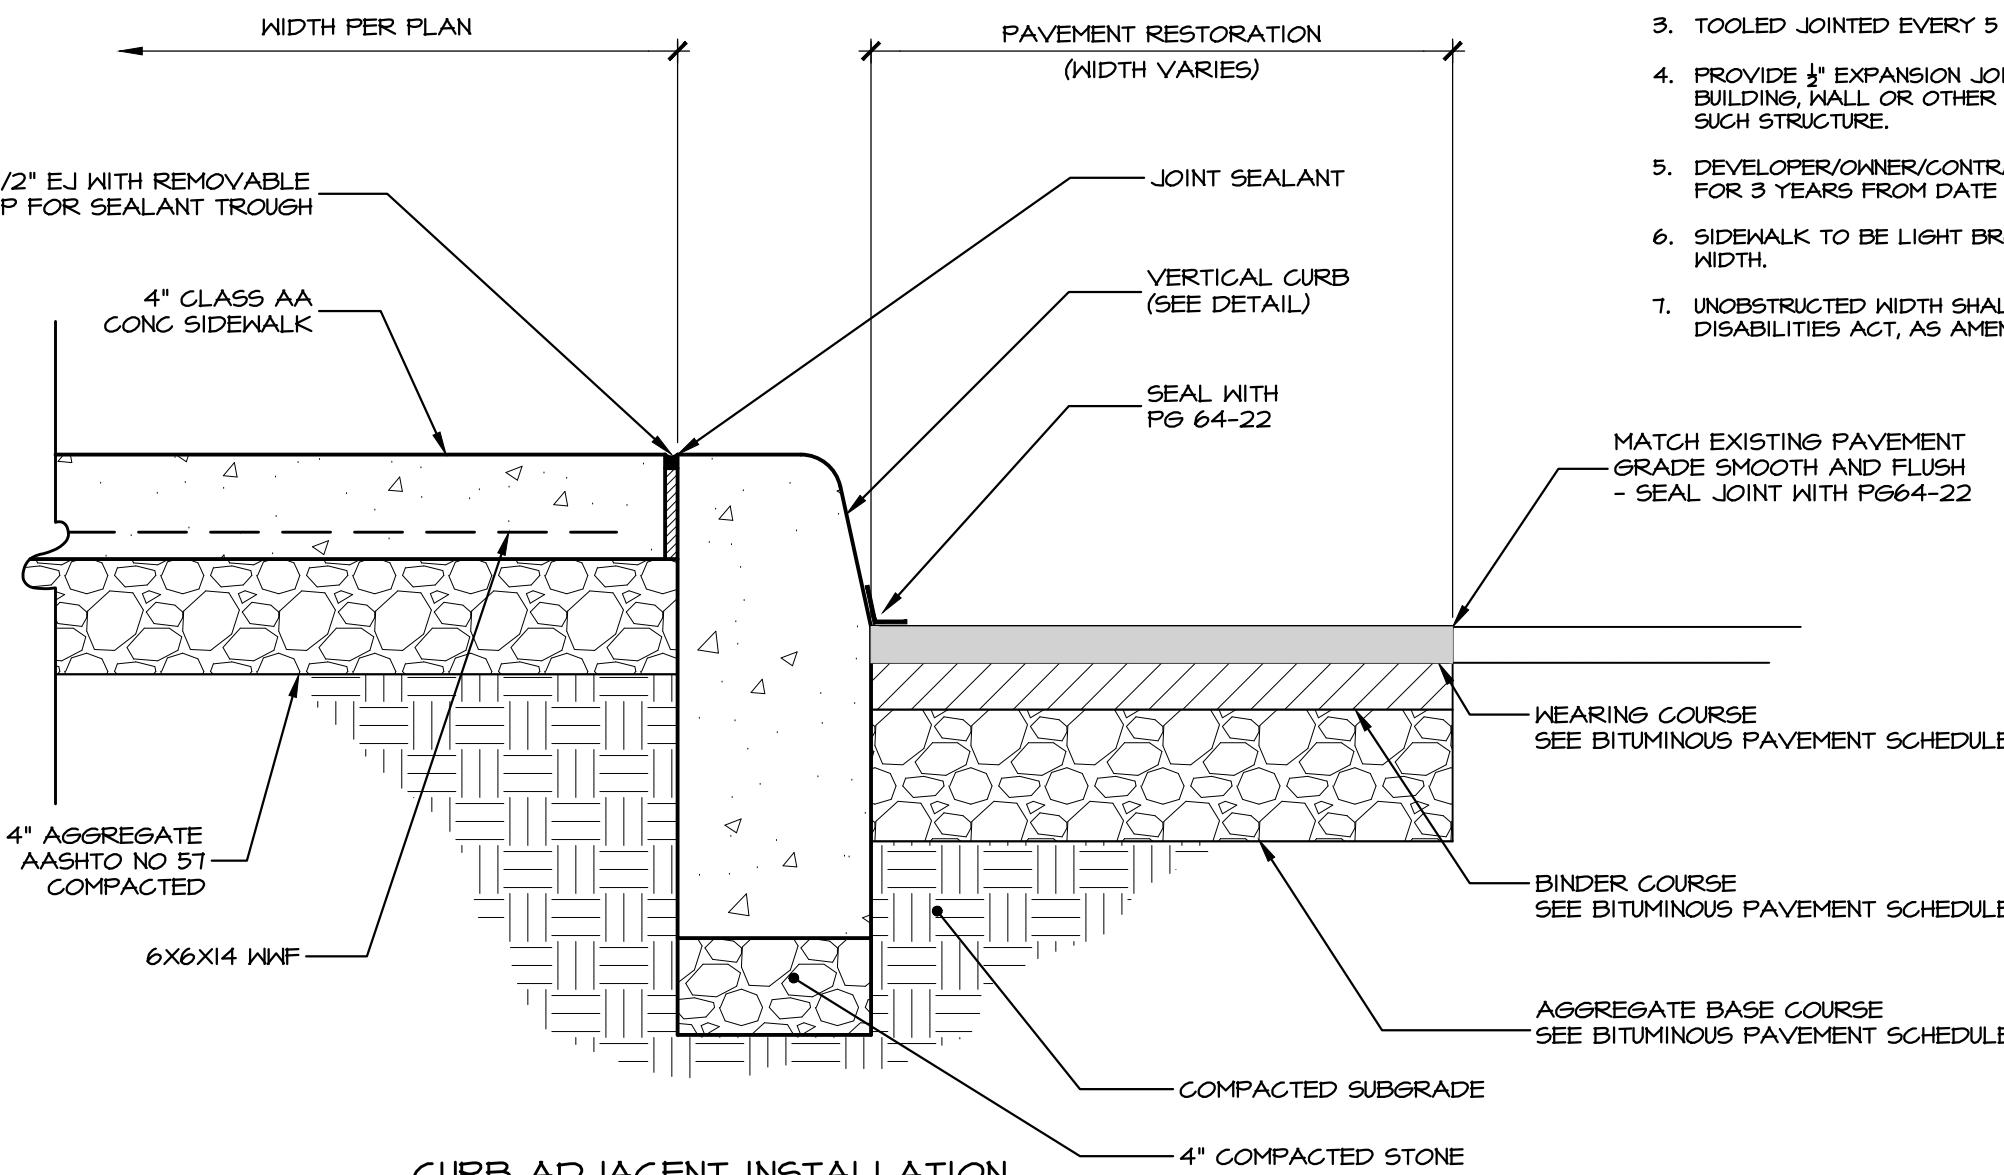NO SCALE



**PLAN VIEW****(F) RADIAL SCORING JOINT**

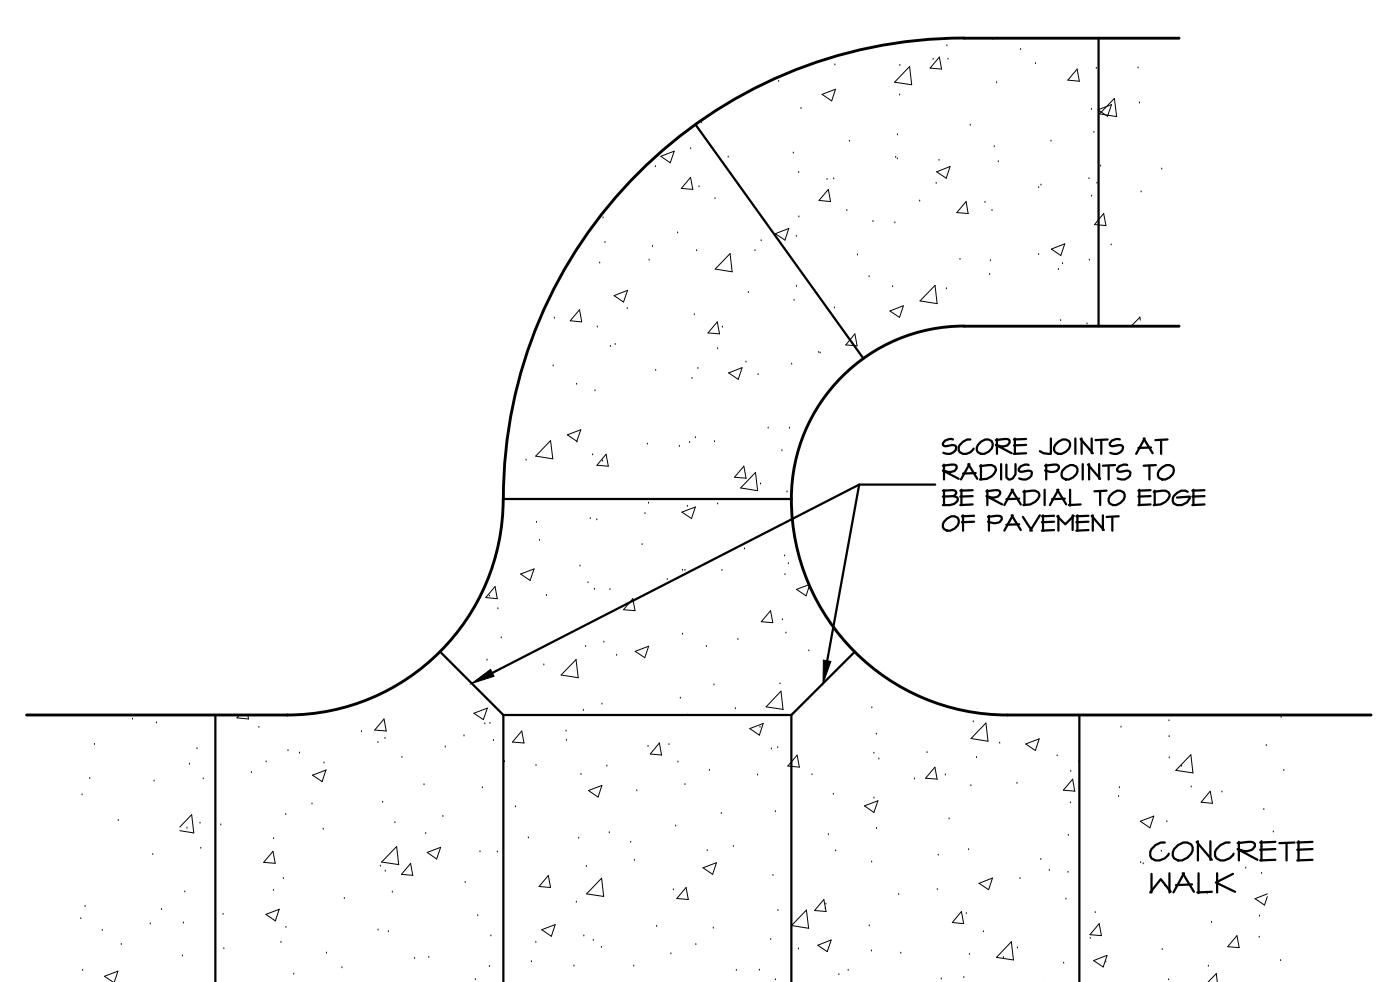PAV-101


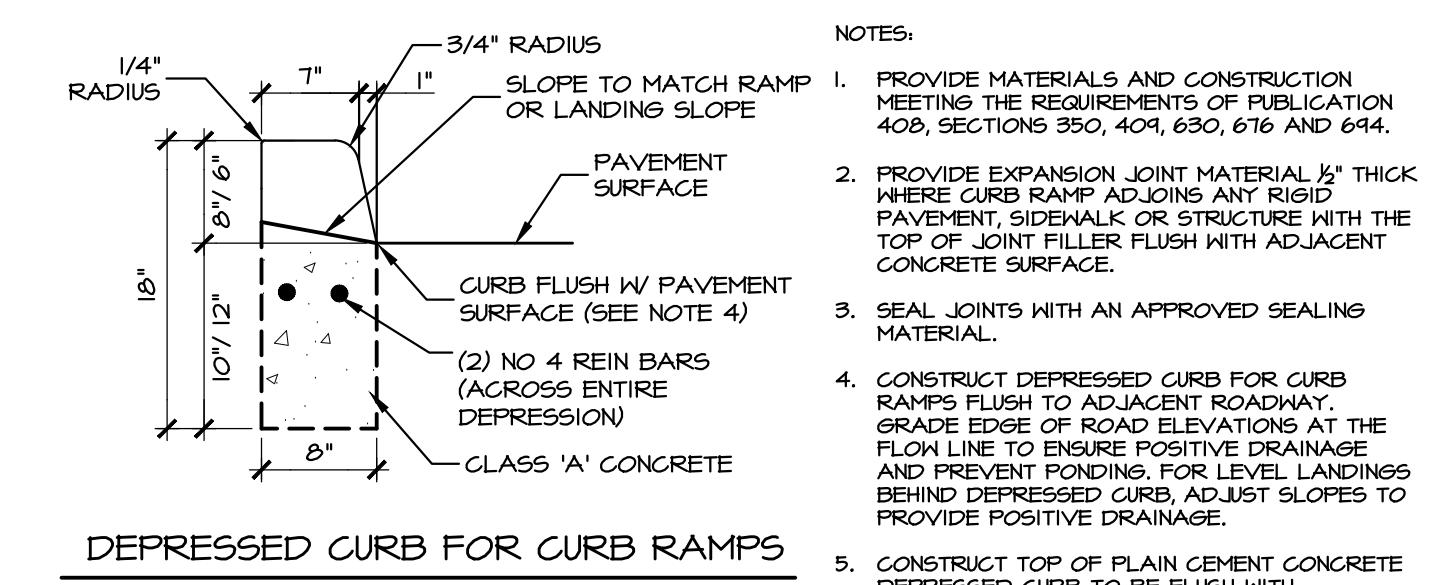
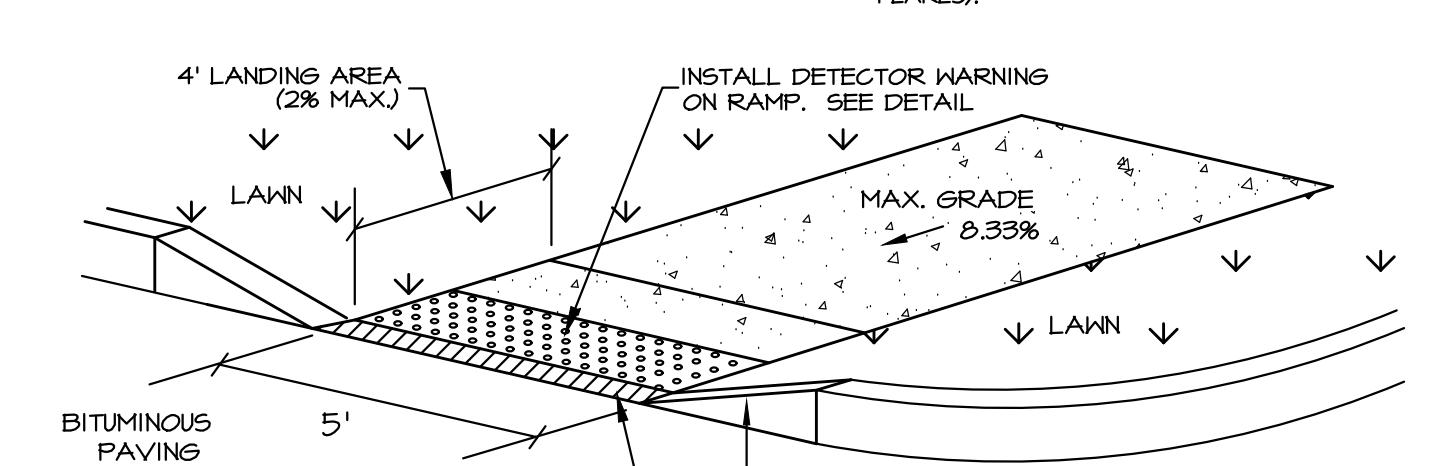
**DEPRESSED CURB FOR CURB RAMPS****(G) ACCESSIBLE RAMP DETAIL**

NO SCALE






REVISIONS PER:	DATE:	BY:
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MANAGER:	BDG	DATE:	JAN. 5, 2024
DESIGNER:	DJM	PROJECT NO.	1212-002
DRAWN BY:	BLM	SCALE:	1" = 50'

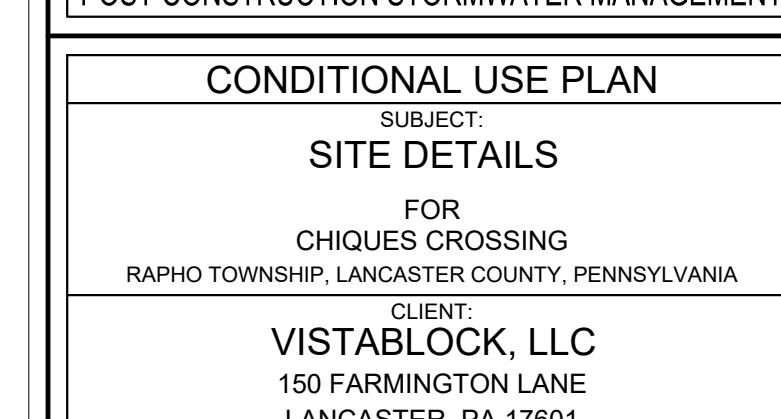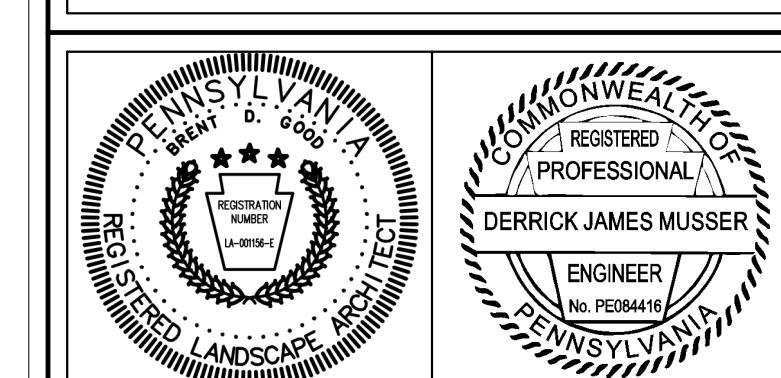


**A TYPICAL ACCESS DRIVE CROSS-SECTION**

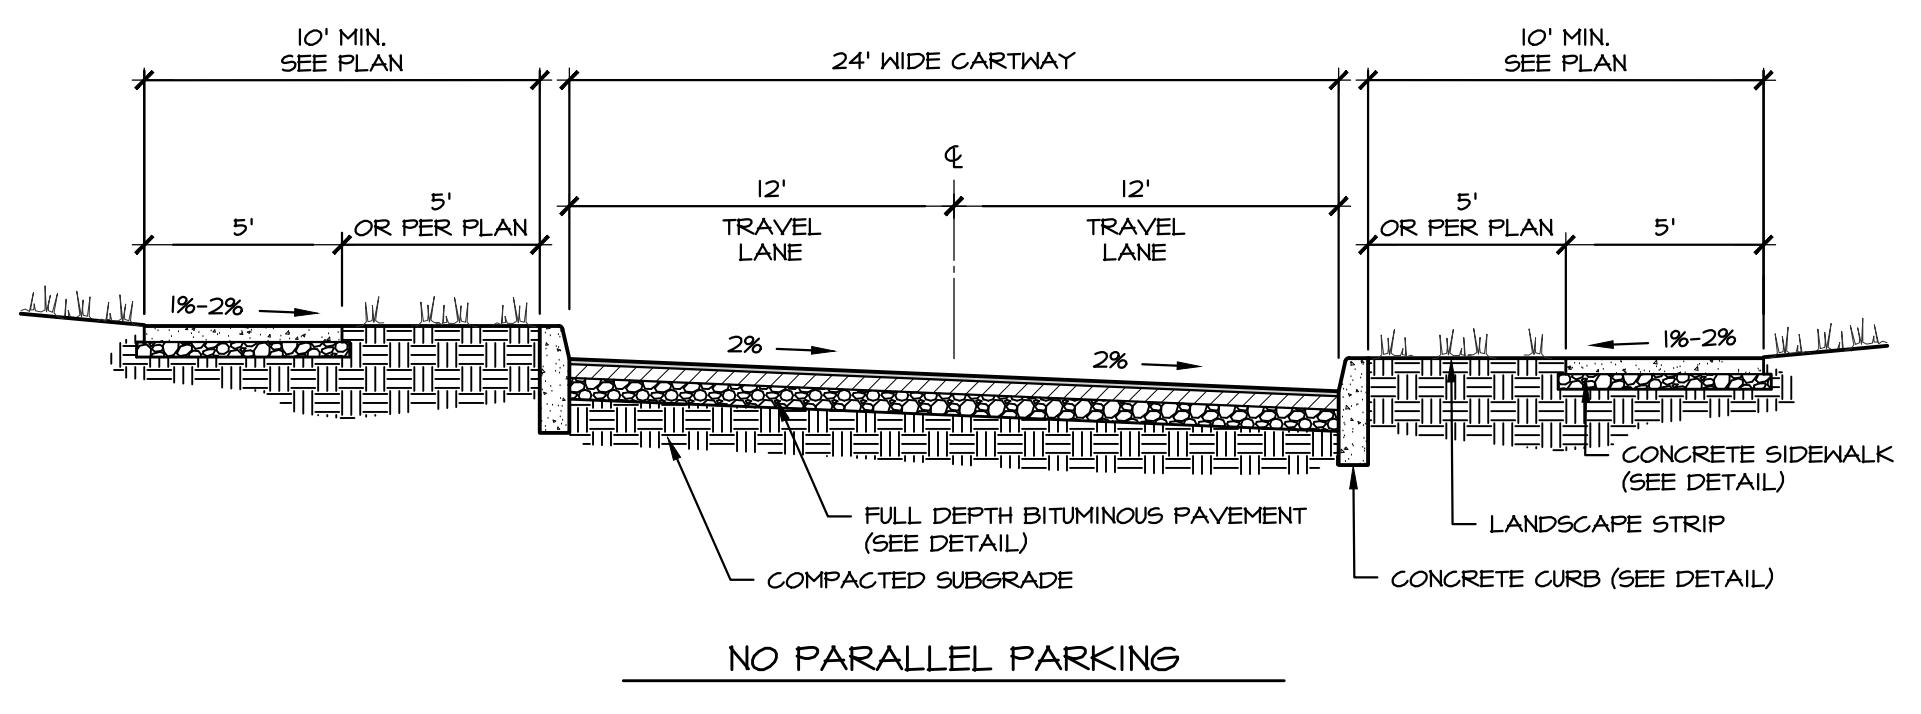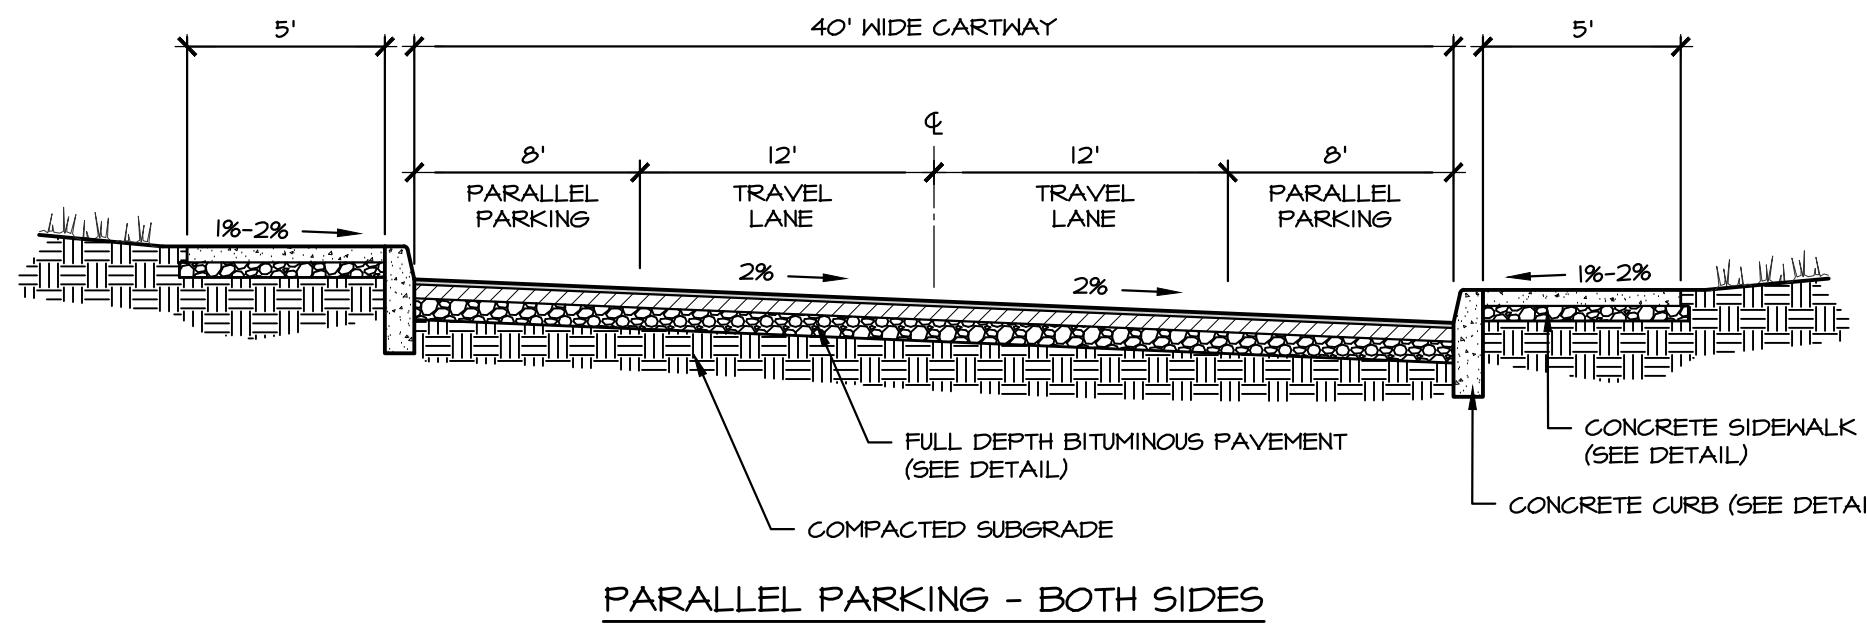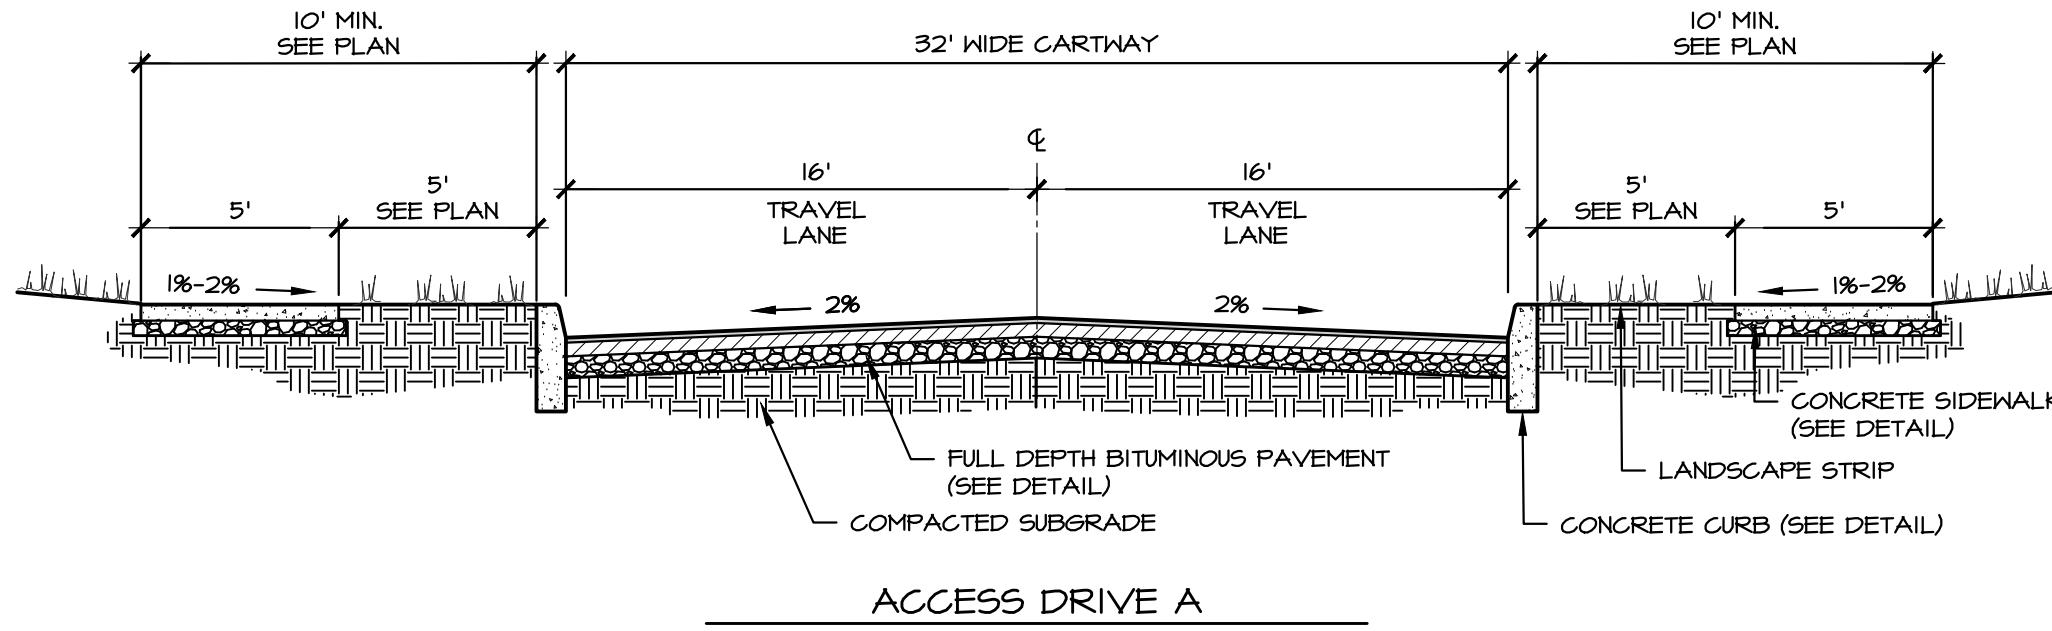

REVISIONS PER:	DATE:	BY:
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**EA group, inc.**  
ENGINEERS • LANDSCAPE ARCHITECTS

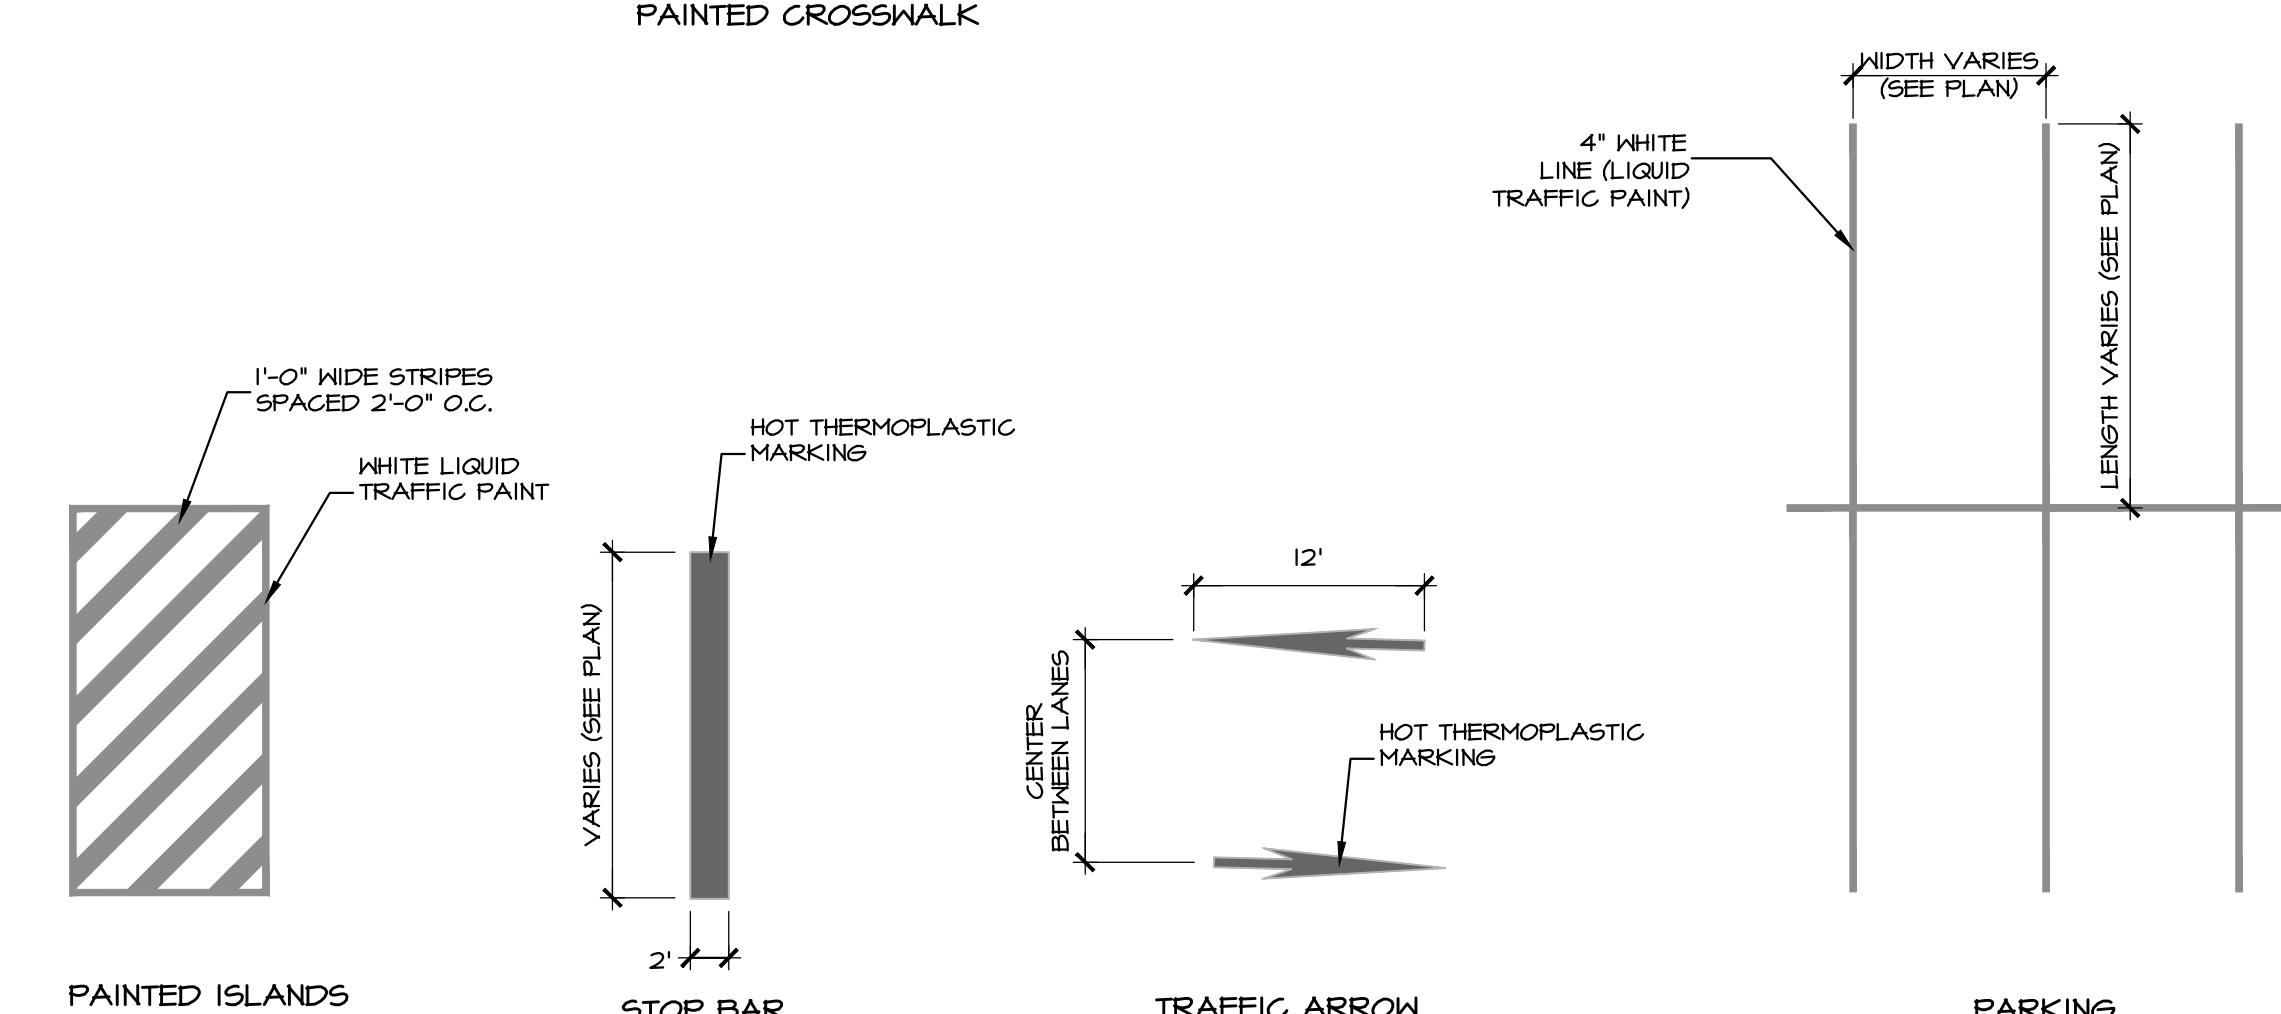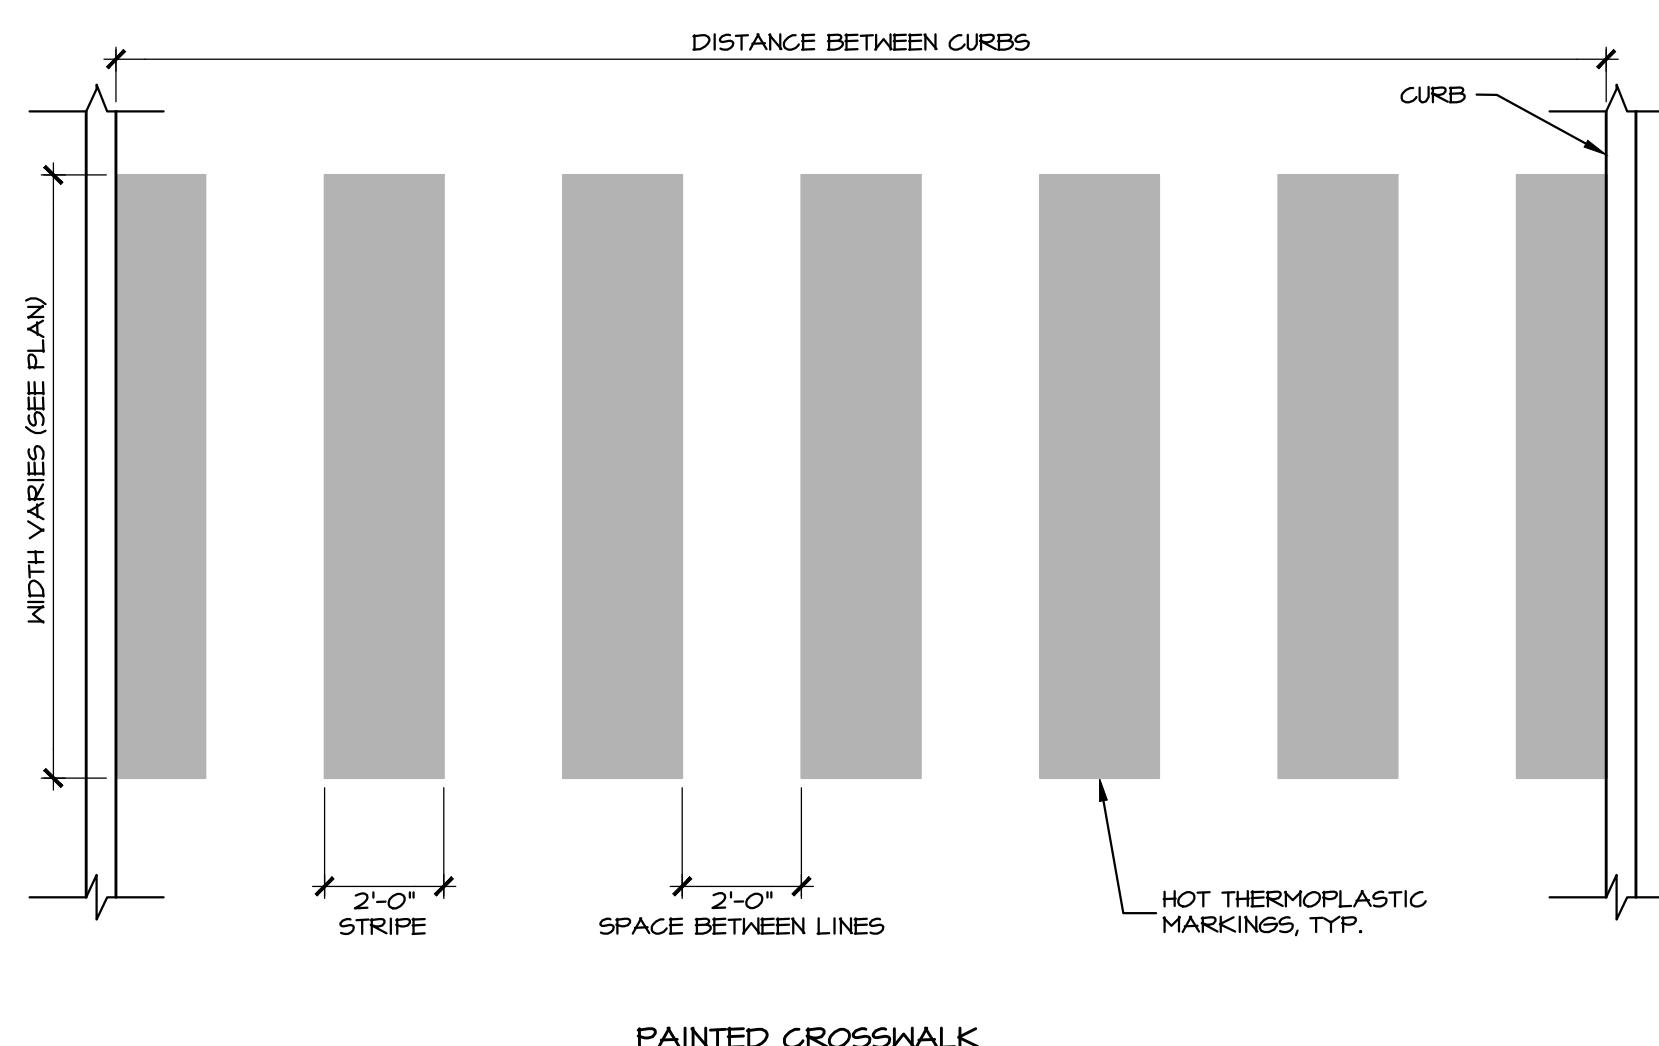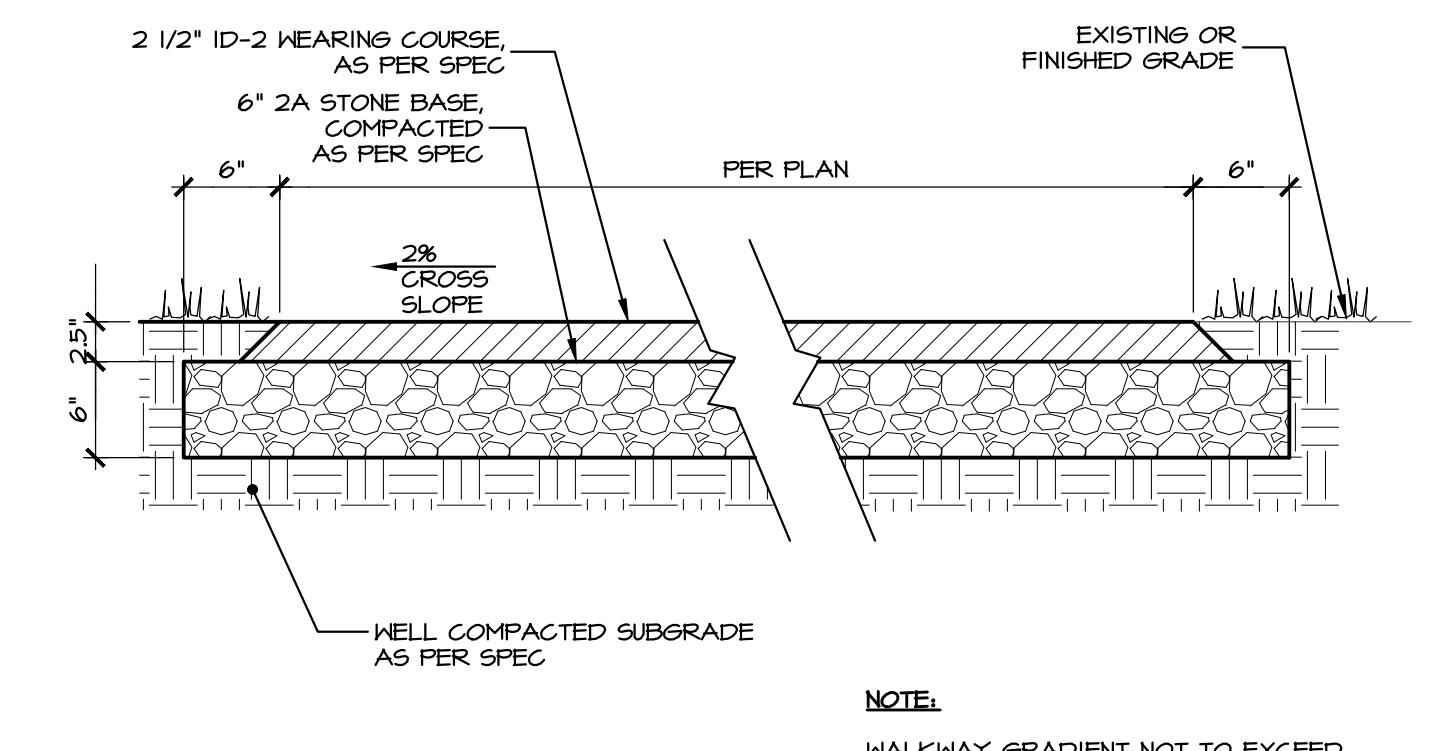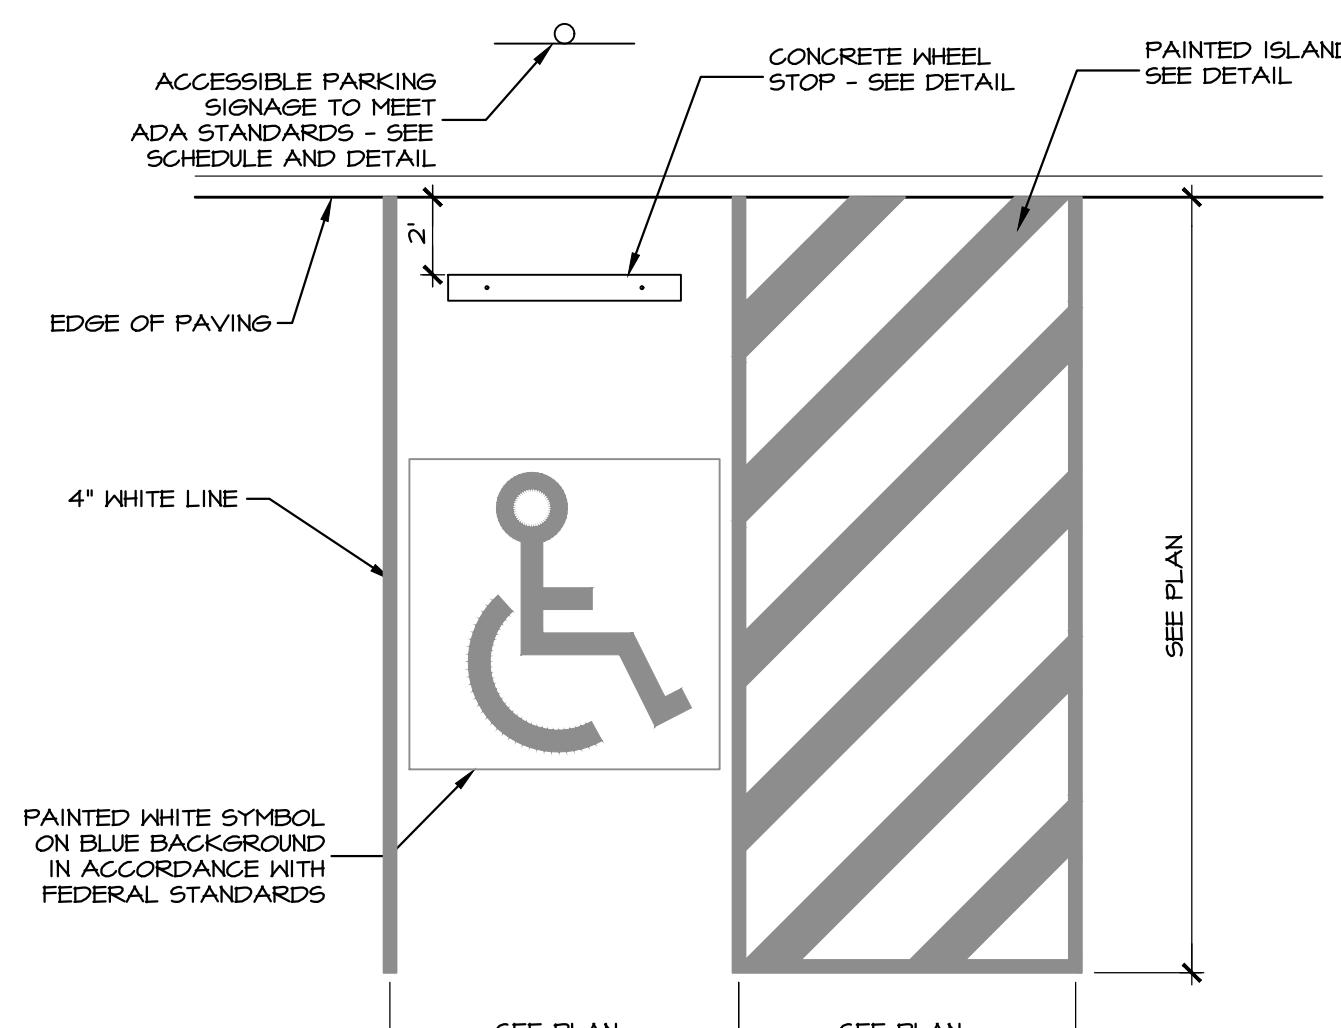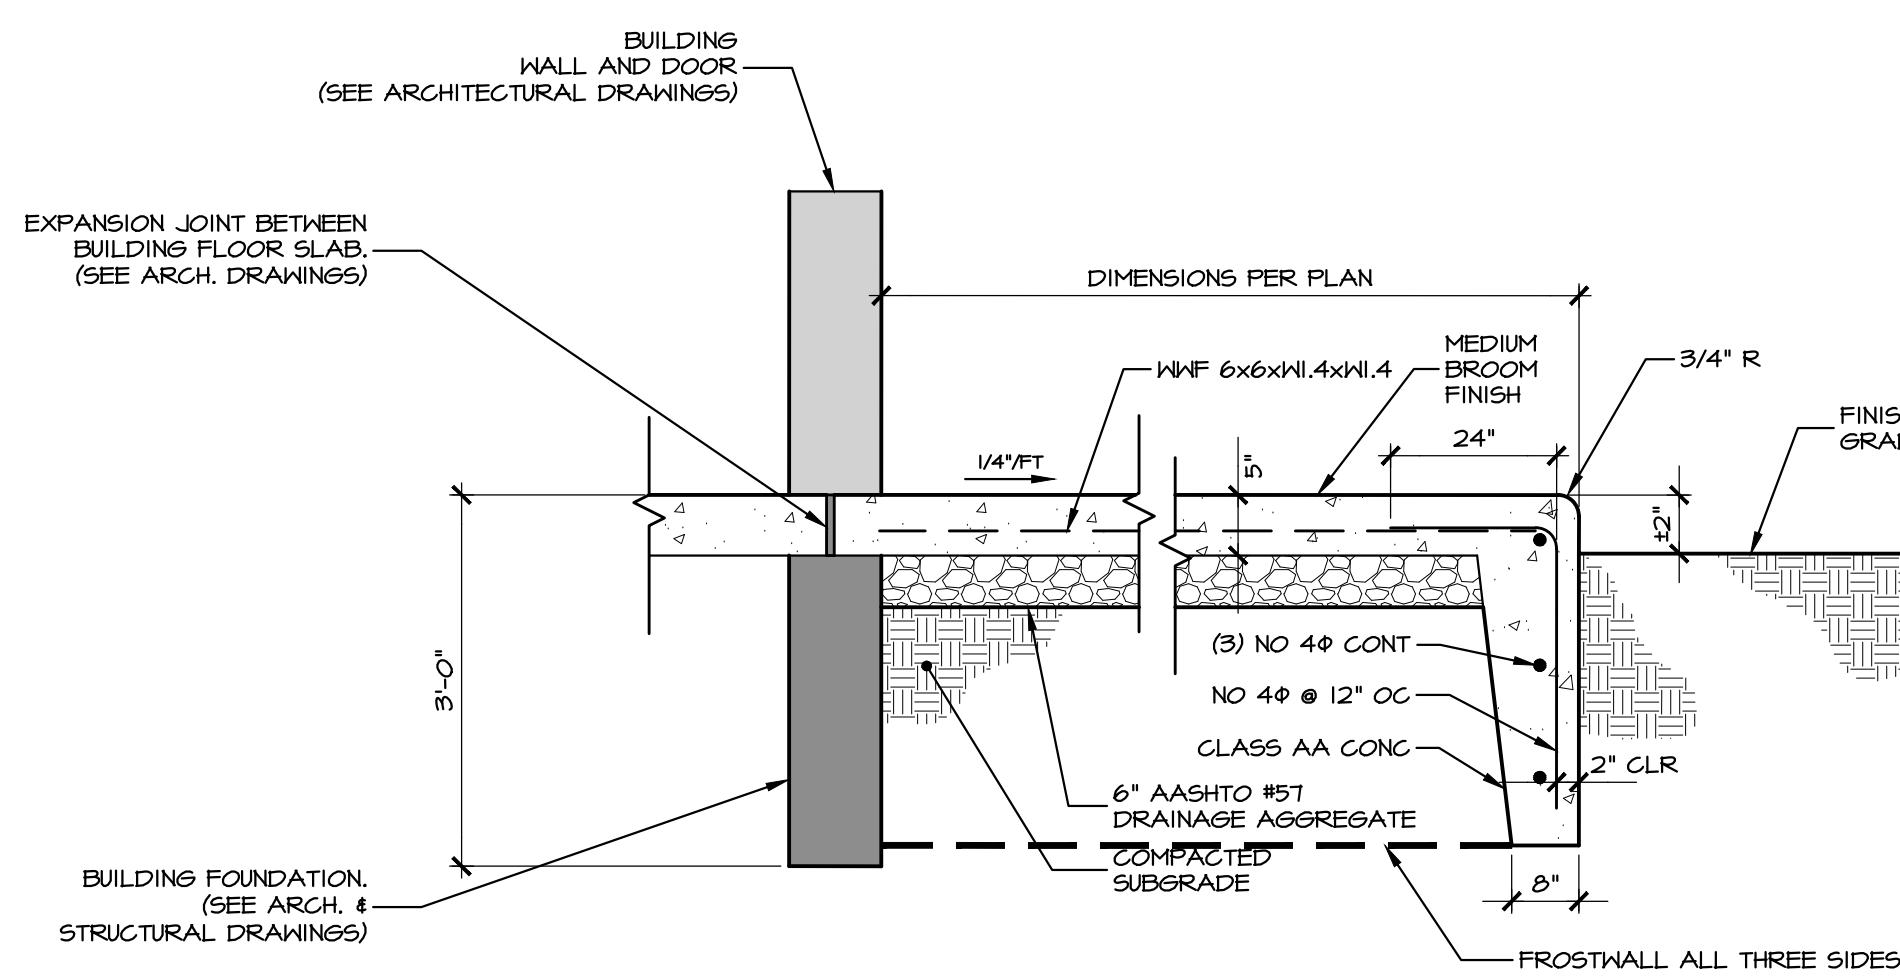743 S. BROAD ST.  
LITITZ, PA 17543  
(717) 626-7271  
elagroup.com

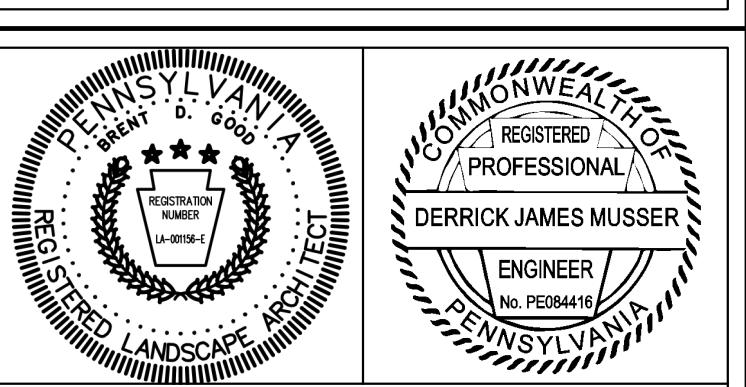

CONDITIONAL USE PLAN SUBJECT: SITE DETAILS FOR CHIQUES CROSSING RAPHO TOWNSHIP, LANCASTER COUNTY, PENNSYLVANIA		
CLIENT: VISTABLOCK, LLC 150 FARMINGTON LANE LANCASTER, PA 17601 717-682-8775		

MANAGER: BDG	DATE: JAN 5, 2024
DESIGNER: DJM	PROJECT NO. 1212-002
DRAWN BY: BLM	SCALE: 1" = 50'